

- All works to be in accordance with Auckland council standards.
- Co-ordinates in terms of NZ Geodetic Datum Mt Eden 2000. Levels in terms of the Auckland Vertical Datum 1946.
- . It is the contractors responsibility to locate all services that may be affected by his operations.
- Each connection shall be marked by a 50mmx50mm treated pine stake extending 600mm above ground level with the top painted This marker post shall be placed alongside a timber marker installed at the time of pipelaying and extending from the connection to 150mm below finished ground level. Connections shall be accurately indicated on "as built" plans.
- Approved hardfill is to be used in backfilling of al road crossings and vehicle crossings to council standards.
- All Manholes are to be 1050mmØ unless shown otherwise.
- All lines to be abandoned shall be sealed at each end. timing of all sealing to be coordinated with council staff.
- All pipes are to be class 2 unless it is to be installed within the road reserve. In this case, the pipe is to be upgraded to class 4.






Н	S92	RFI	ML	04/2023		
G	EPA	RFI		ML	02/2022	
F	EPA	RFI		ML	02/2023	
Е	EPA	RFI	ML	10/2022		
Rev	Desc	ription	Ву	Date		
,		Ву	Date	Date		
Survey		SURVEYWORX	12/20	12/2021		
Design		JV	01/2022			
Drawn		MS	02/20	02/2022		
Check	red	.IP	02/20	02/2022		





62, 78 & 80 PAPAKURA -**CLEVEDON ROAD, CLEVEDON, AUCKLAND FOR CLEVEDON PROPERTIES LTD**


PROPOSED STORMWATER DRAINAGE PLAN


Project no.	194006		
Scale	1:500 @ A3		
Cad file	C400- DRAINAGE.DWG		
Drawing no.	C414	Rev	Н

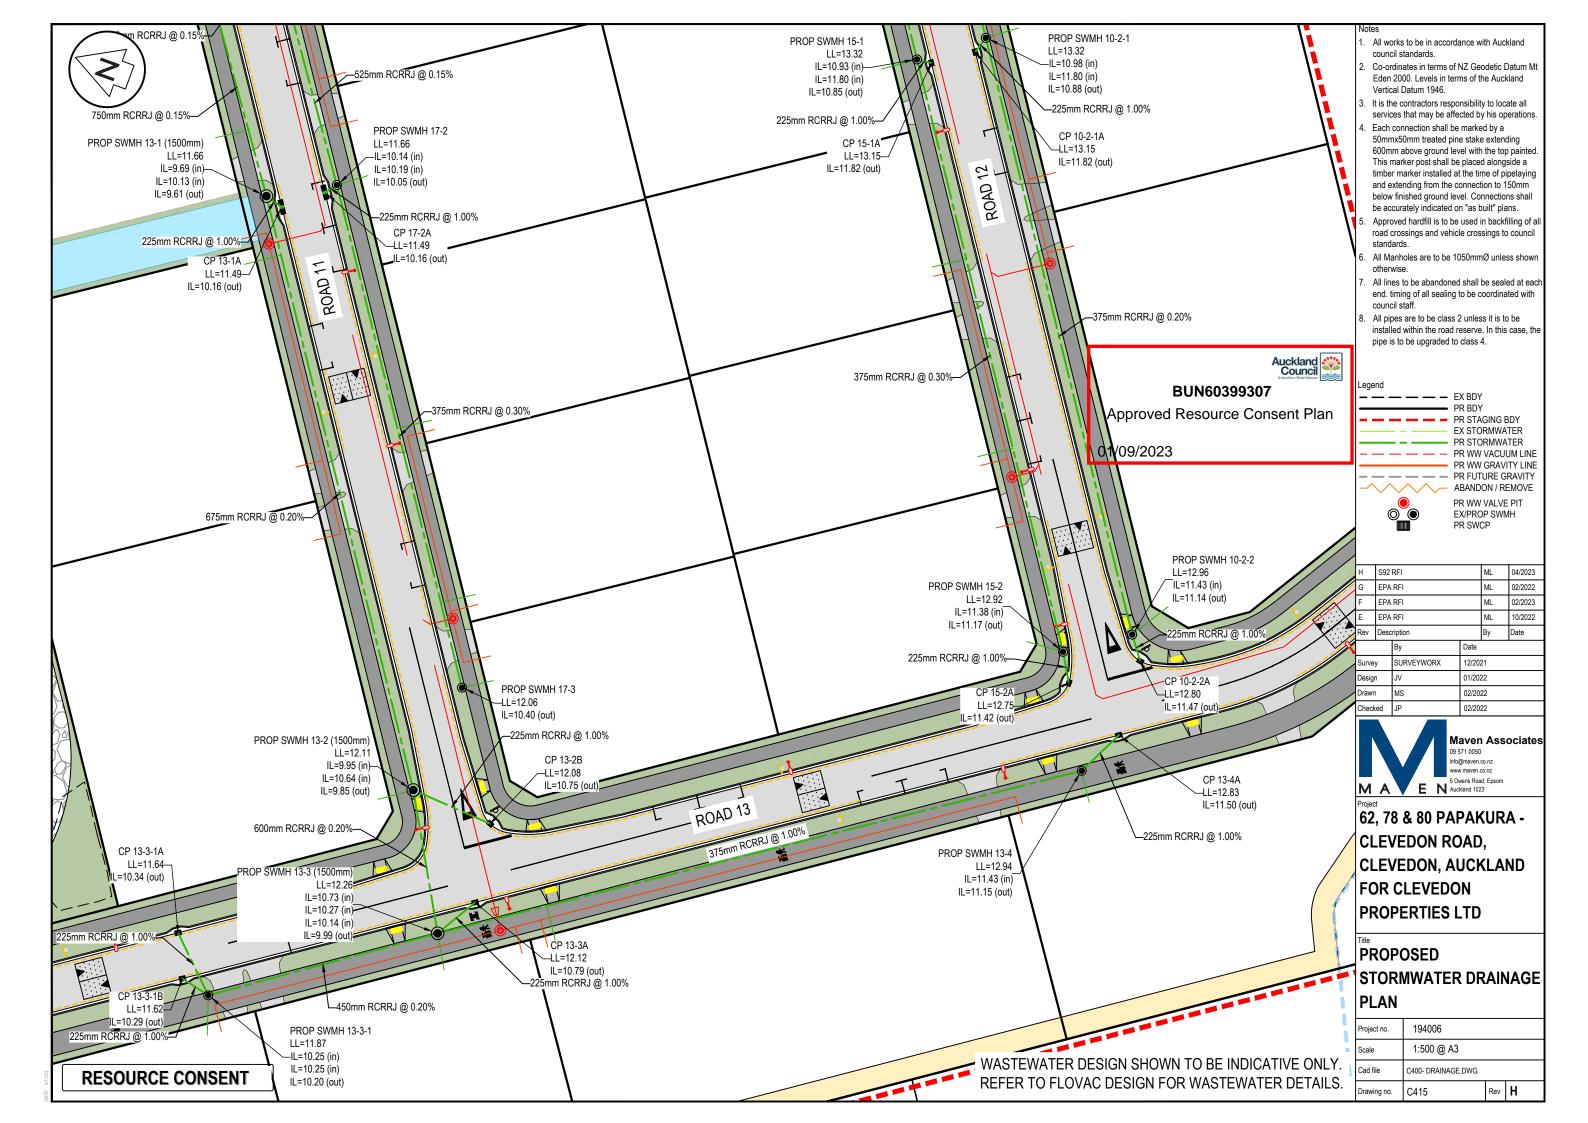


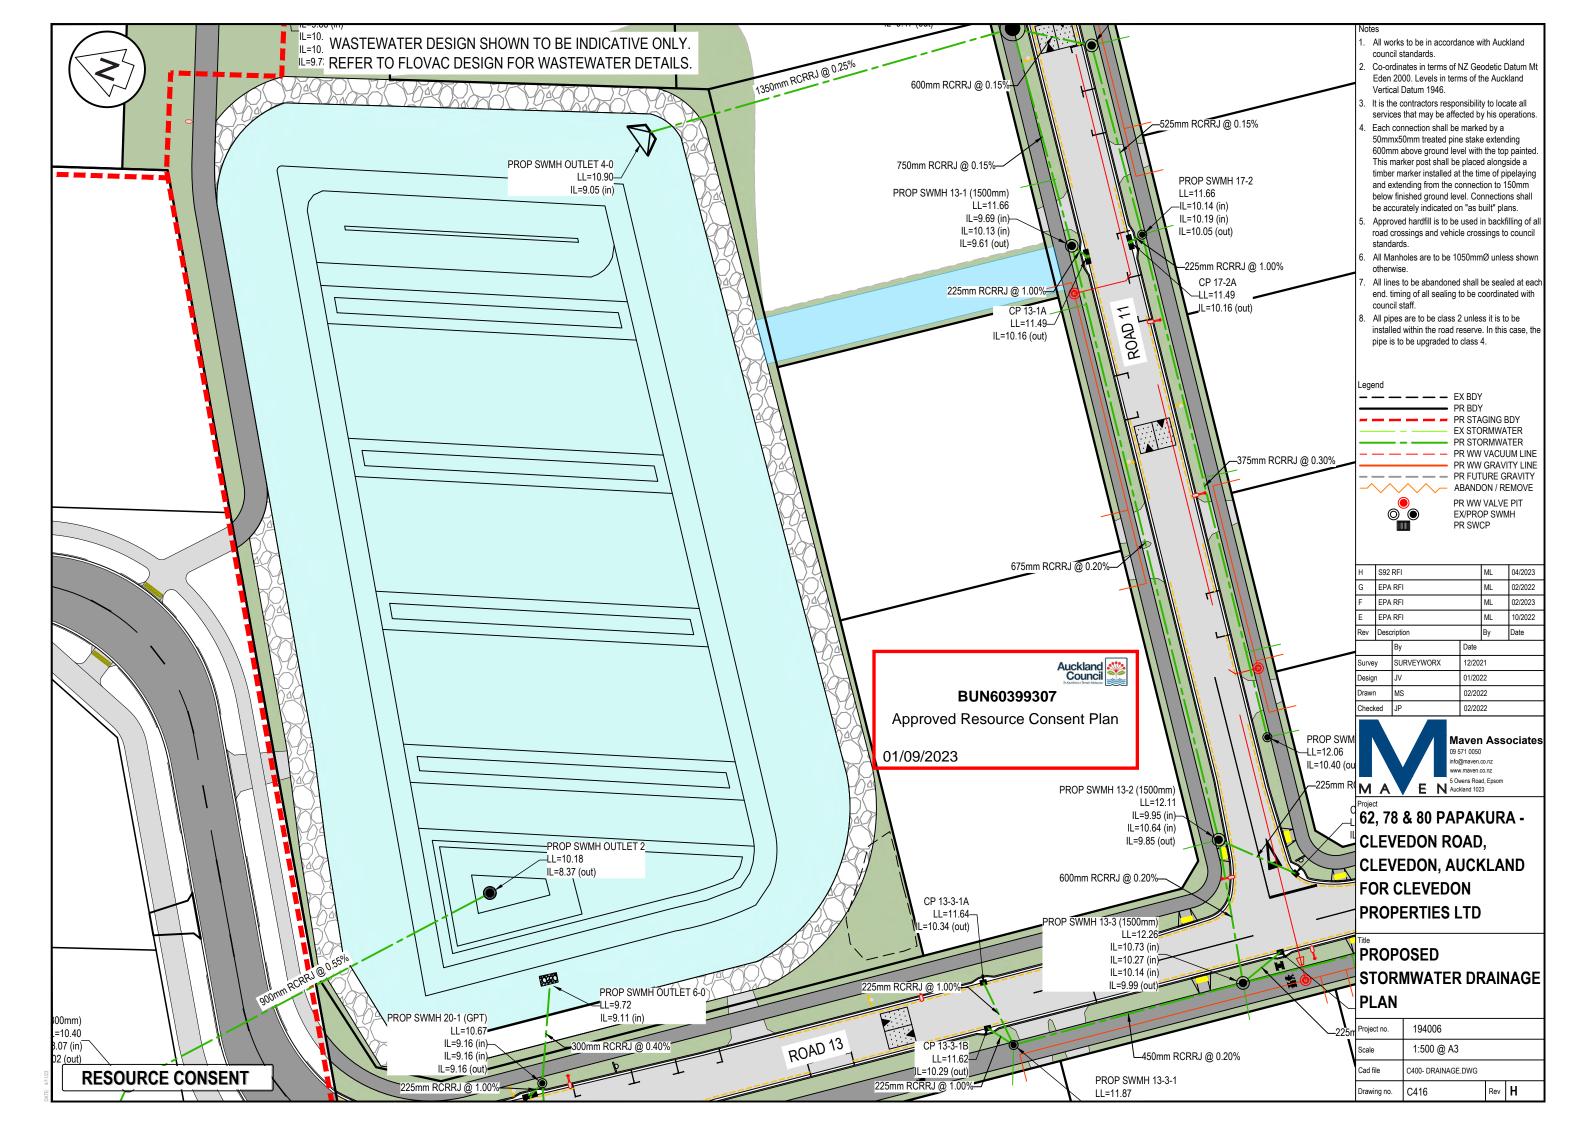

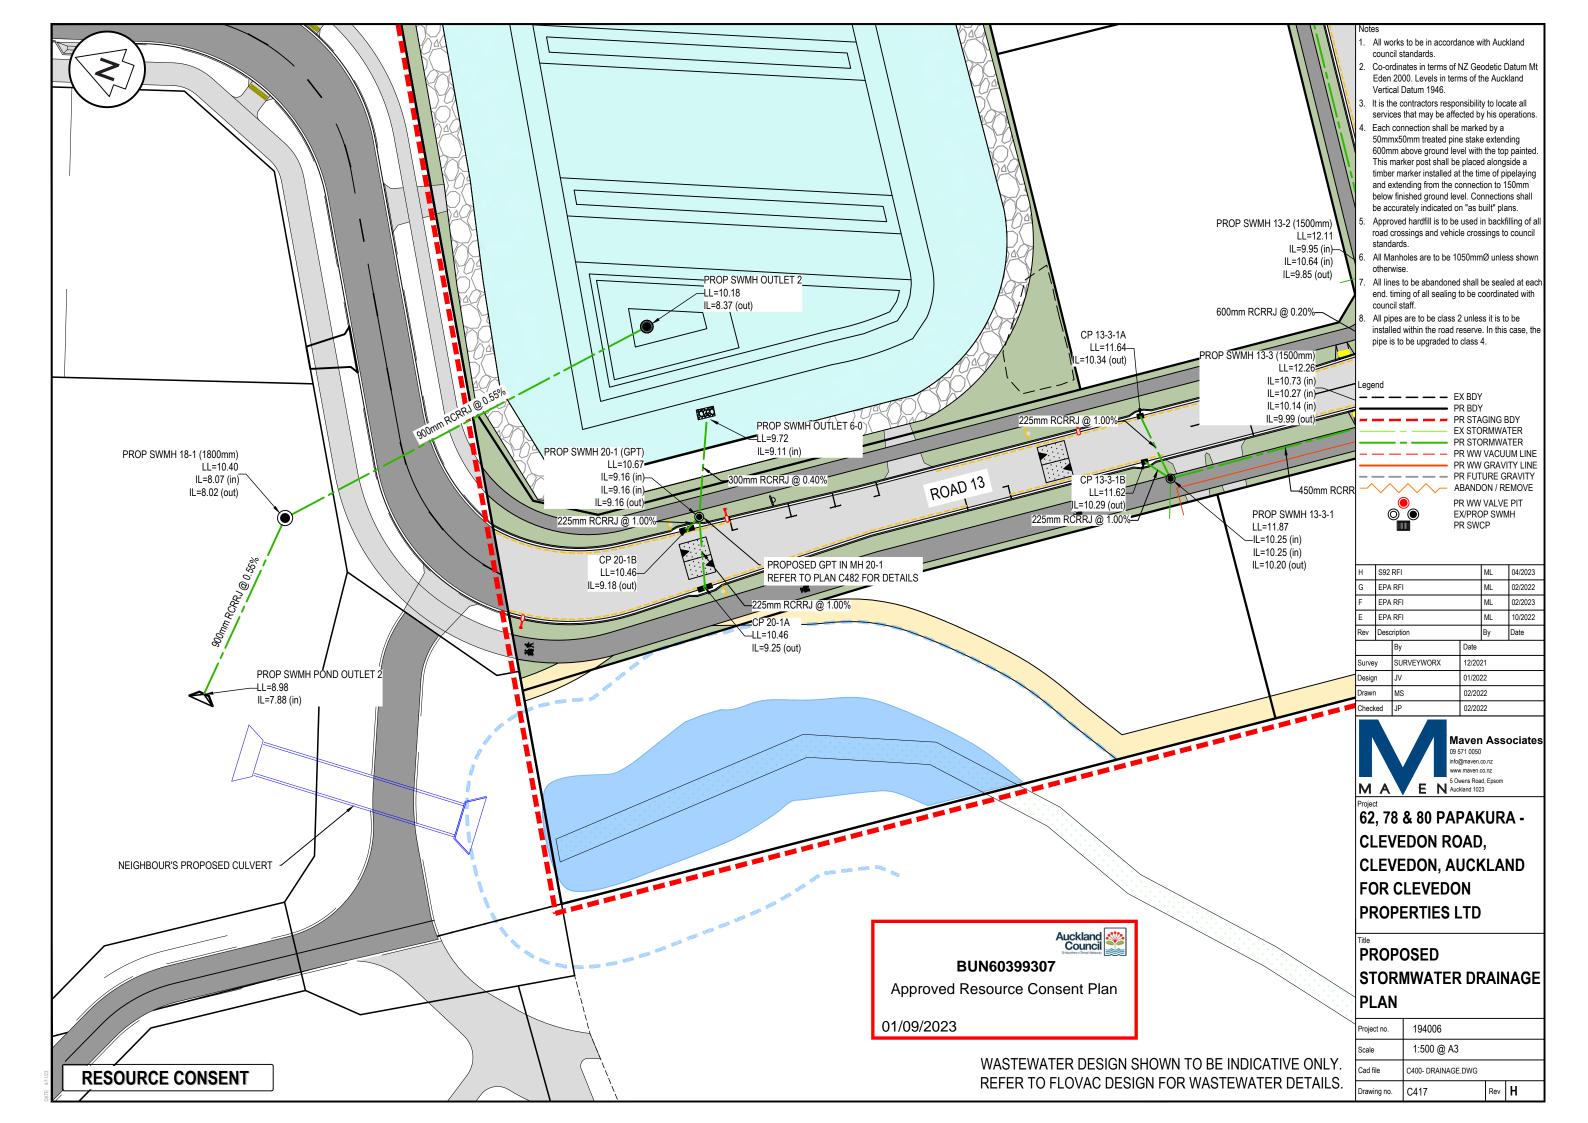

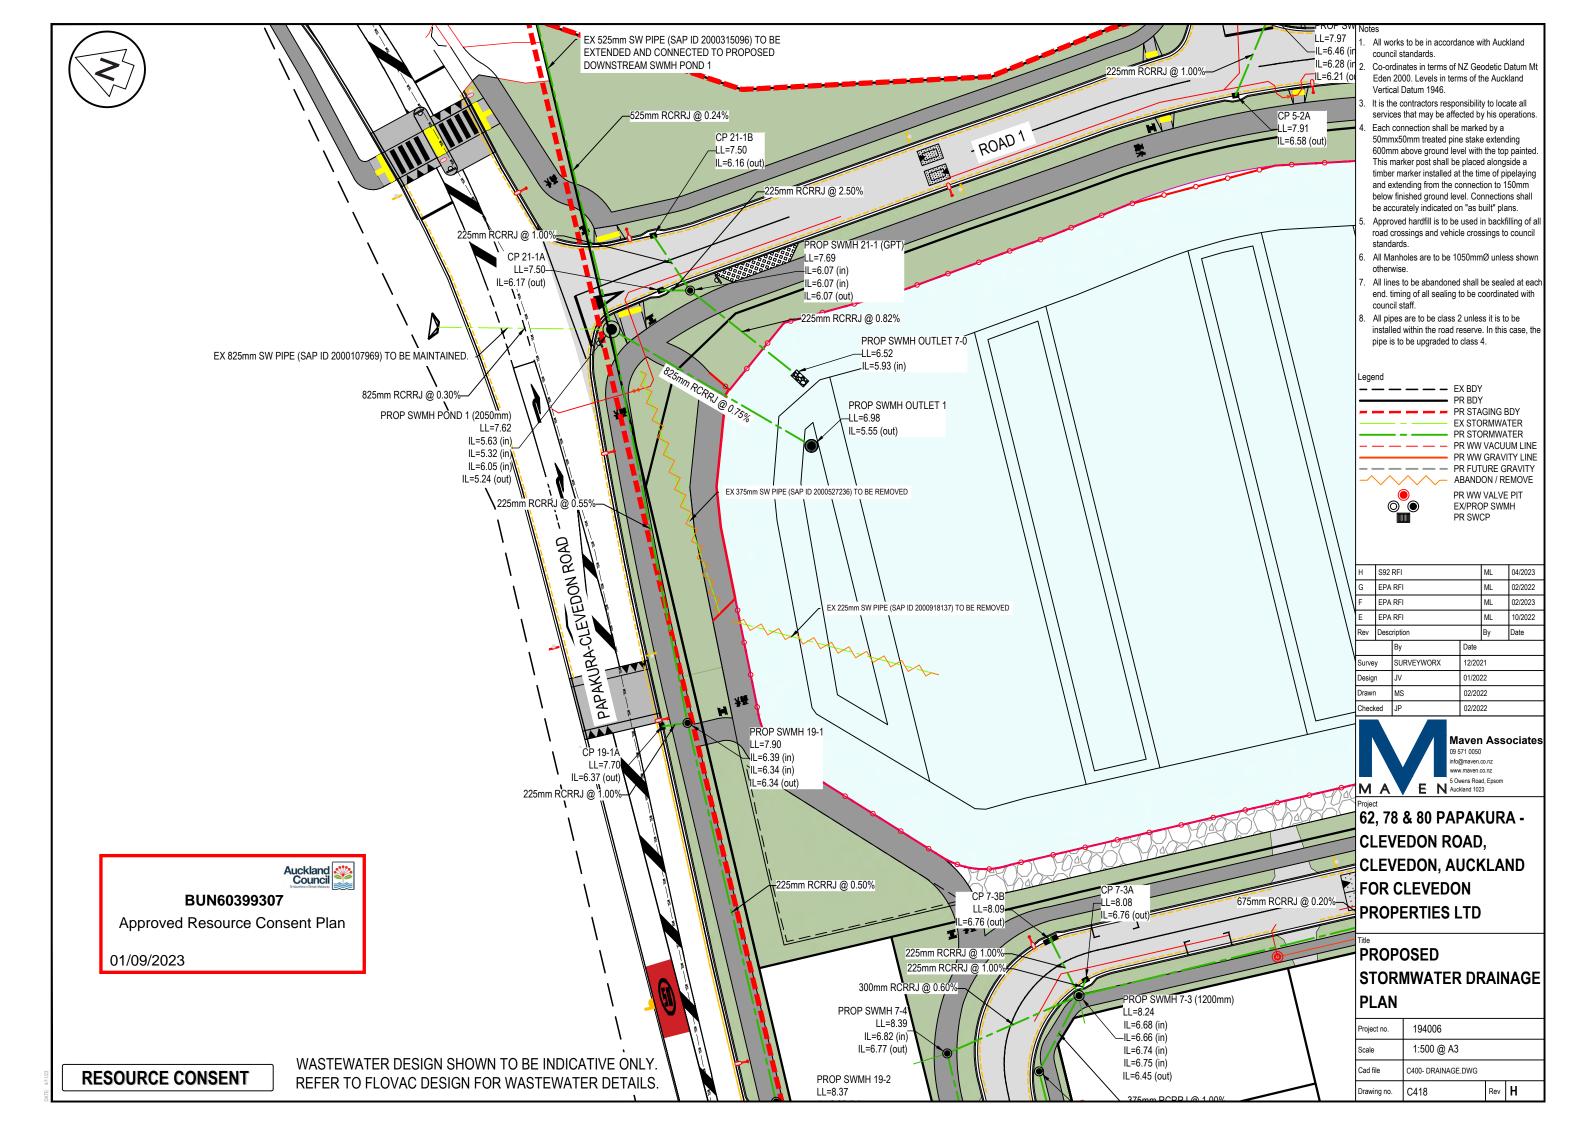

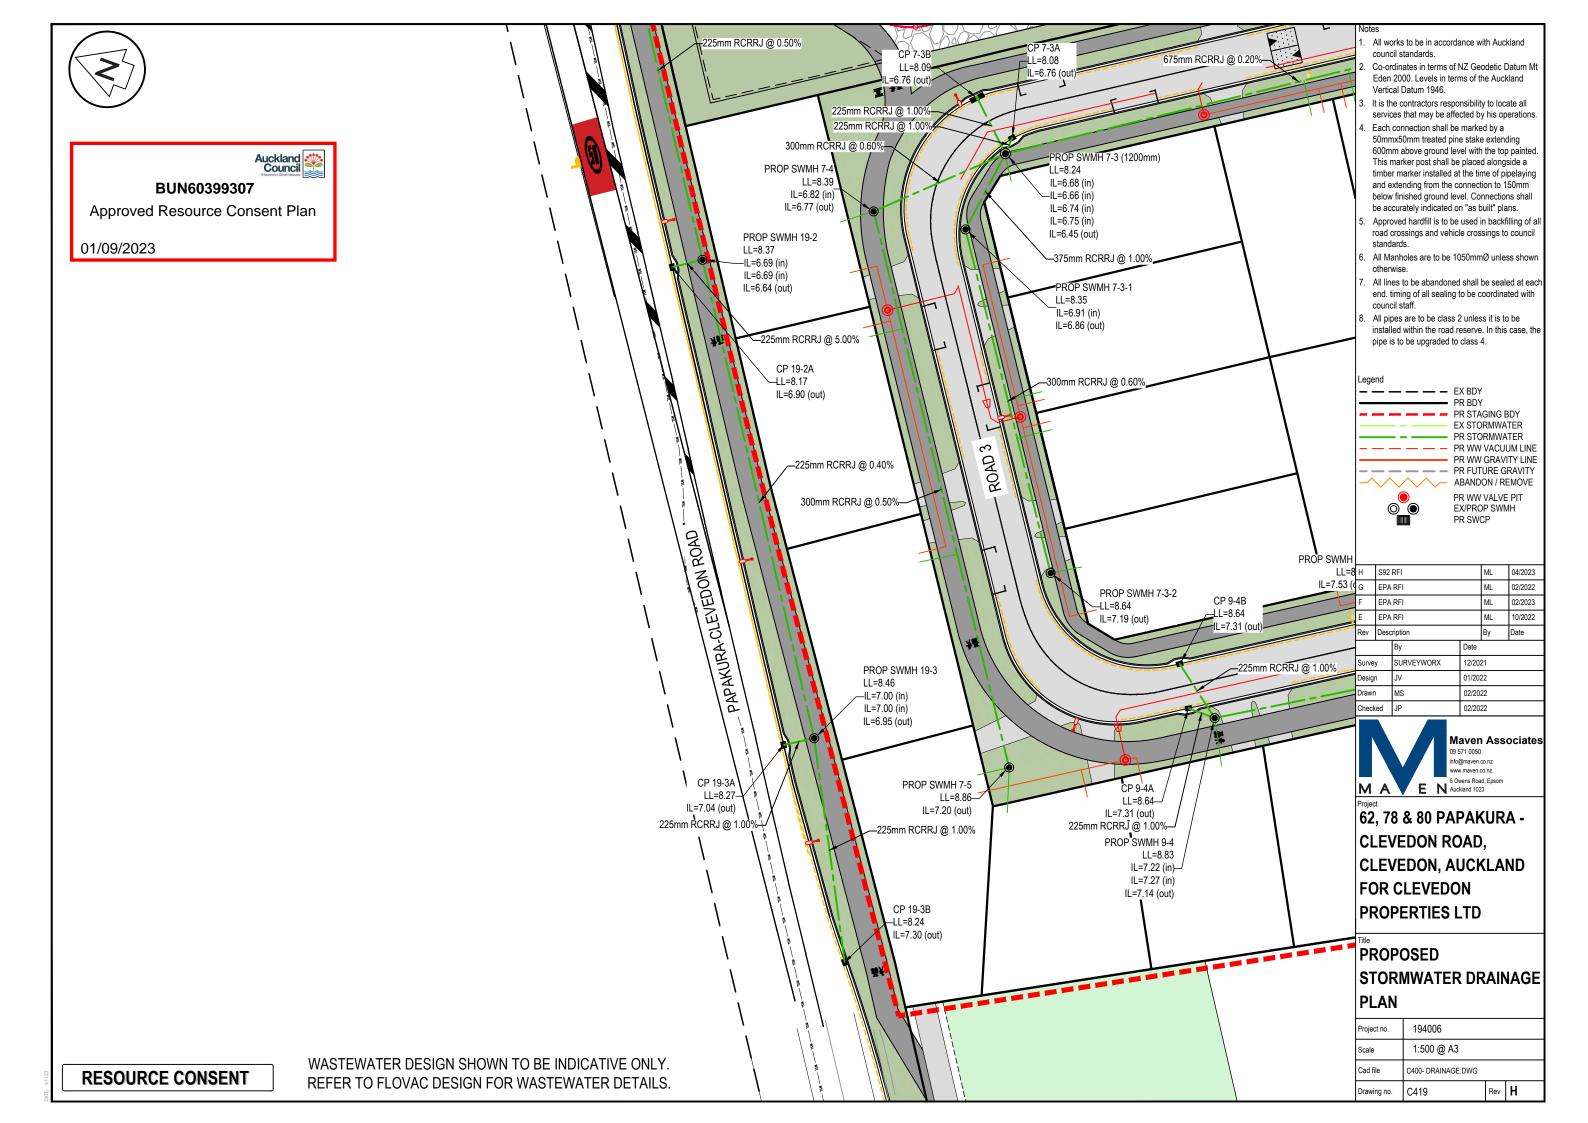

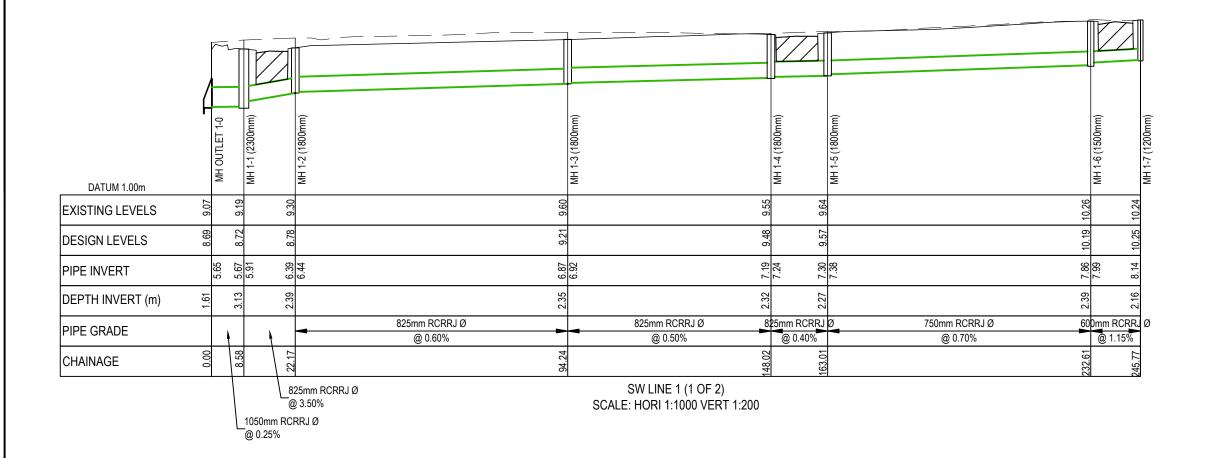



SW LINE 1 (2 OF 2) SCALE: HORI 1:1000 VERT 1:200

BUN60399307
Approved Resource Consent Plan
01/09/2023

Notes

- All works to be in accordance with Auckland council standards.
- Co-ordinates in terms of NZ Geodetic Datum Mt Eden 2000. Levels in terms of the Auckland Vertical Datum 1946.
- It is the contractors responsibility to locate all services that may be affected by his operations.
- Pipe bedding: 0 10% granular bedding,10 -20% weak concrete bedding.greater than 20% weak concrete bedding (7mpa plus anti scour blocks at 6m crs).
- 5. Each connection shall be marked by a 50mmx50mm treated pine stake extending 600mm above ground level with the top painted This marker post shall be placed alongside a timber marker installed at the time of pipelaying and extending from the connection to 150mm below finished ground level. Connections shall be accurately indicated on "as built" plans.
- Approved hardfill is to be used in backfilling of all road crossings and vehicle crossings to council standards.
- Heavy duty manhole lids and frames to be used in trafficked areas.
- All Manholes are to be 1050mmØ unless shown otherwise.
- Catchpit leads with 800mm or less cover shall be protected with concrete capping.
- All lines to be abandoned shall be sealed at each end. timing of all sealing to be coordinated with council staff.



	Н	S92	RFI	ML	04/2023	
	G	G EPA RFI				02/2022
	F	EPA	RFI		ML	02/2023
	Е	E EPA RFI				10/2022
	Rev	Desc	ription	Ву	Date	
			Ву	Date		
	Surve	y	SURVEYWORX	12/2021		
	Design Drawn		JV	01/2022		
			MS	02/2022		
	Check	ed	JP	02/20	22	



62, 78 & 80 PAPAKURA CLEVEDON ROAD,
CLEVEDON, AUCKLAND
FOR CLEVEDON
PROPERTIES LTD

PROPOSED
STORMWATER DRAINAGE
LONG SECTIONS

Project no. 194006

Scale 1:1000 @ A3


Cad file C400- DRAINAGE.DWG

Drawing no. C420 Rev H




Approved Resource Consent Plan


01/09/2023

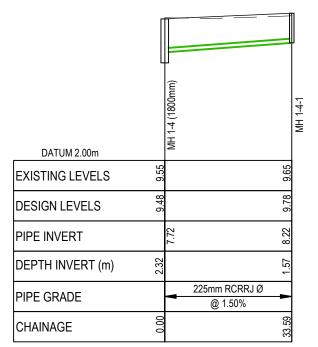


SW LINE 1-4-1 SCALE: HORI 1:1000 VERT 1:200

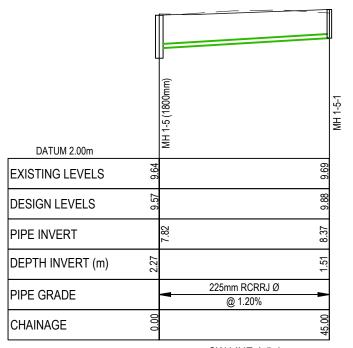


SW LINE 1-5-1 SCALE: HORI 1:1000 VERT 1:200

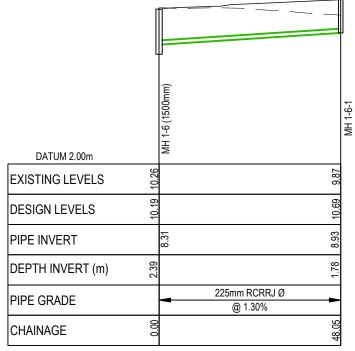

SW LINE 1-6-1 SCALE: HORI 1:1000 VERT 1:200

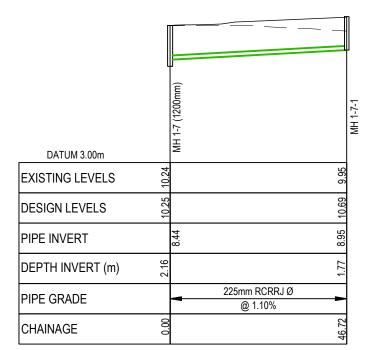

SW LINE 1-7-1 SCALE: HORI 1:1000 VERT 1:200

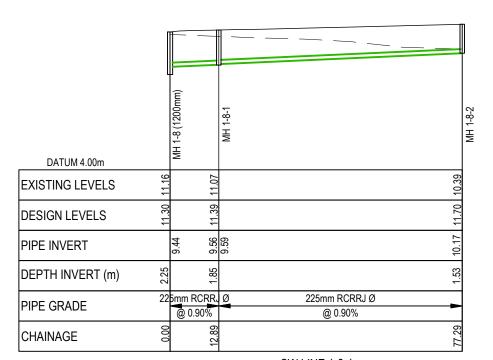

SW LINE 1-8-1 SCALE: HORI 1:1000 VERT 1:200

Note

- All works to be in accordance with Auckland council standards
 - Co-ordinates in terms of NZ Geodetic Datum Mt Eden 2000. Levels in terms of the Auckland Vertical Datum 1946.
- It is the contractors responsibility to locate all services that may be affected by his operations.
- Pipe bedding: 0 10% granular bedding,10 -20% weak concrete bedding.greater than 20% weak concrete bedding (7mpa plus anti scour blocks at 6m crs).
- 5. Each connection shall be marked by a 50mmx50mm treated pine stake extending 600mm above ground level with the top painted This marker post shall be placed alongside a timber marker installed at the time of pipelaying and extending from the connection to 150mm below finished ground level. Connections shall be accurately indicated on "as built" plans.
- Approved hardfill is to be used in backfilling of all road crossings and vehicle crossings to council standards.
- 7. Heavy duty manhole lids and frames to be used in trafficked areas.
- All Manholes are to be 1050mmØ unless shown otherwise.
- Catchpit leads with 800mm or less cover shall be protected with concrete capping.
- All lines to be abandoned shall be sealed at each end. timing of all sealing to be coordinated with council staff.

Legend	
	EX GROUND LEVEL PROP FINISHED LEVEL HARDFILL BACKFILL

	Н	S92	RFI		ML	04/2023
	G	EPA	RFI		ML	02/2022
	F	EPA	PA RFI			02/2023
	E EPA RFI			ML	10/2022	
	Rev	Desc	scription		Ву	Date
			Ву	Date		
	Surve	y	SURVEYWORX	12/2021		
	Design Drawn		JV	01/2022		
			MS	02/2022		
	Chook	- A	ID	00/0000		



62, 78 & 80 PAPAKURA -CLEVEDON ROAD, CLEVEDON, AUCKLAND FOR CLEVEDON PROPERTIES LTD

PROPOSED
STORMWATER DRAINAGE
LONG SECTIONS


Project no.	194006		
Scale	1:1000 @ A3		
Cad file	C400- DRAINAGE.DWG		
Drawing no.	C421	Rev	Н




BUN60399307

Approved Resource Consent Plan


01/09/2023

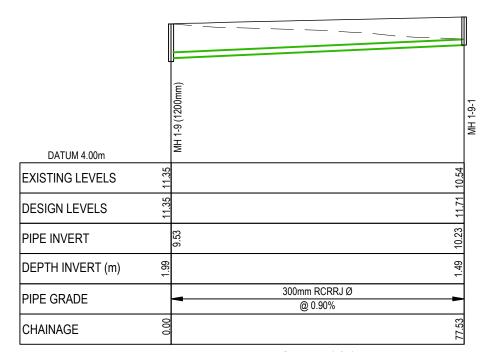

SW LINE 1-9-1 SCALE: HORI 1:1000 VERT 1:200

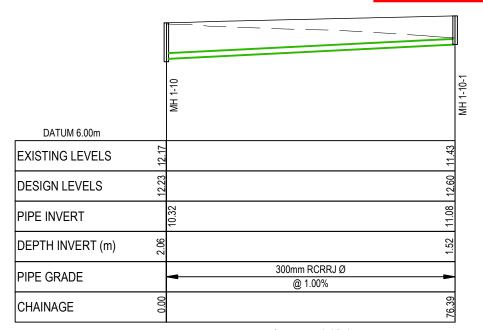

SW LINE 1-10-1 SCALE: HORI 1:1000 VERT 1:200

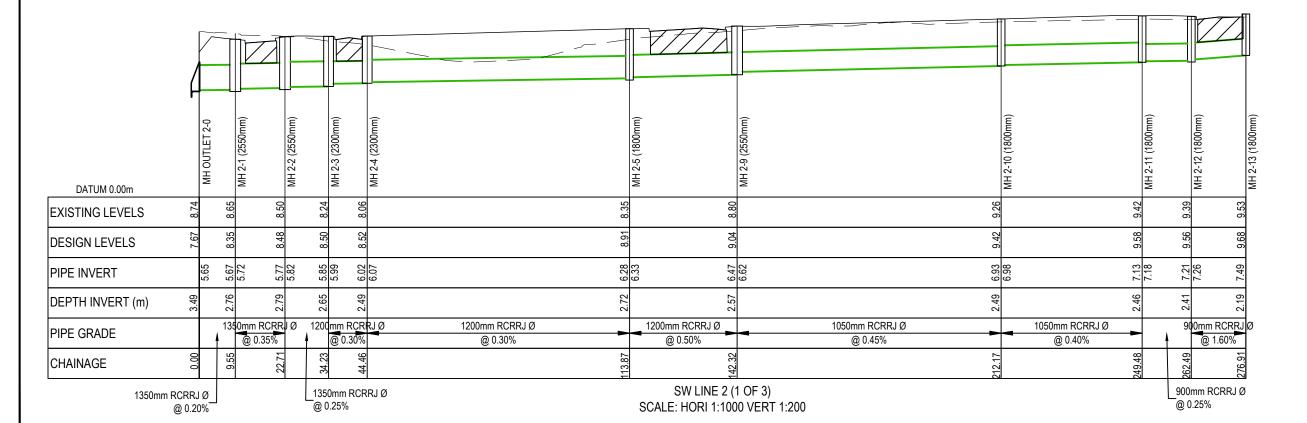

Note

- All works to be in accordance with Auckland council standards.
- Co-ordinates in terms of NZ Geodetic Datum Mt Eden 2000. Levels in terms of the Auckland Vertical Datum 1946.
- It is the contractors responsibility to locate all services that may be affected by his operations.
- Pipe bedding: 0 10% granular bedding,10 -20% weak concrete bedding.greater than 20% weak concrete bedding (7mpa plus anti scour blocks at 6m crs).
- Each connection shall be marked by a 50mmx50mm treated pine stake extending 600mm above ground level with the top painted. This marker post shall be placed alongside a timber marker installed at the time of pipelaying and extending from the connection to 150mm below finished ground level. Connections shall be accurately indicated on "as built" plans.
- Approved hardfill is to be used in backfilling of all road crossings and vehicle crossings to council standards.
- 7. Heavy duty manhole lids and frames to be used in trafficked areas.
- All Manholes are to be 1050mmØ unless shown otherwise.
- Catchpit leads with 800mm or less cover shall be protected with concrete capping.
- All lines to be abandoned shall be sealed at each end. timing of all sealing to be coordinated with council staff.



	Н	S92	RFI		ML	04/2023	
	G EPA RFI			RFI		02/2022	
	F	EPA	EPA RFI		ML	02/2023	
	Е	EPA	RFI	ML	10/2022		
	Rev	Desc	cription		Ву	Date	
			Ву	Date	te		
	Surve	y	SURVEYWORX	12/2021			
	Design Drawn		JV	01/2022			
			MS	02/2022			
	Charl		j.	00/0000			




62, 78 & 80 PAPAKURA CLEVEDON ROAD,
CLEVEDON, AUCKLAND
FOR CLEVEDON
PROPERTIES LTD

PROPOSED
STORMWATER DRAINAGE
LONG SECTIONS


Project no.	194006				
Scale	1:1000 @ A3				
Cad file	C400- DRAINAGE.DWG				
Drawing no.	C422	Rev	Н		

Auckland Council BUN60399307 Approved Resource Consent Plan


01/09/2023

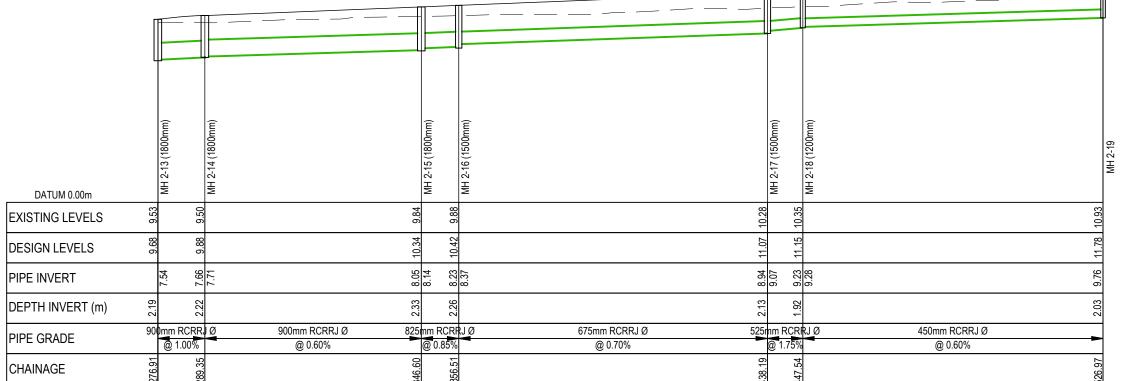

SW LINE 2 (2 OF 3) SCALE: HORI 1:1000 VERT 1:200

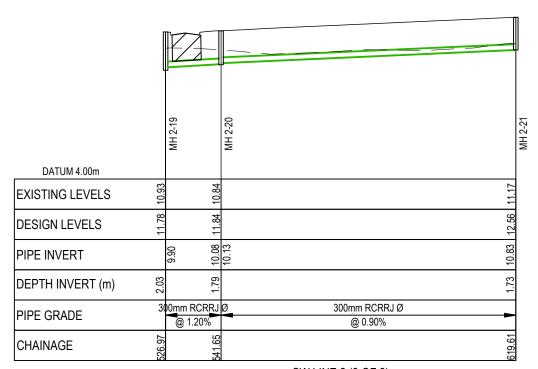

SW LINE 2 (3 OF 3) SCALE: HORI 1:1000 VERT 1:200

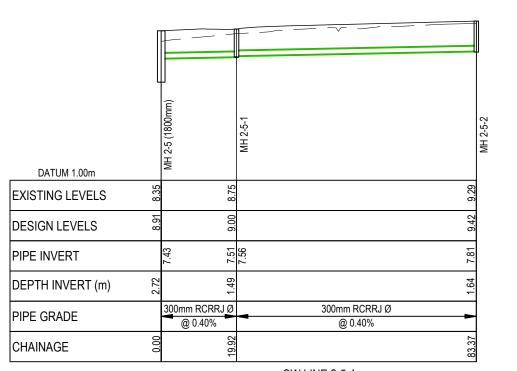

SW LINE 2-5-1 SCALE: HORI 1:1000 VERT 1:200

RESOURCE CONSENT

Notes

- All works to be in accordance with Auckland council standards.
- Co-ordinates in terms of NZ Geodetic Datum Mt Eden 2000. Levels in terms of the Auckland Vertical Datum 1946.
- It is the contractors responsibility to locate all services that may be affected by his operations.
- Pipe bedding: 0 10% granular bedding,10 20% weak concrete bedding.greater than 20% weak concrete bedding (7mpa plus anti scour blocks at 6m crs).
- 5. Each connection shall be marked by a 50mmx50mm treated pine stake extending 600mm above ground level with the top painted This marker post shall be placed alongside a timber marker installed at the time of pipelaying and extending from the connection to 150mm below finished ground level. Connections shall be accurately indicated on "as built" plans.
- Approved hardfill is to be used in backfilling of all road crossings and vehicle crossings to council standards.
- 7. Heavy duty manhole lids and frames to be used in trafficked areas.
- All Manholes are to be 1050mmØ unless shown otherwise.
- Catchpit leads with 800mm or less cover shall be protected with concrete capping.
- All lines to be abandoned shall be sealed at each end. timing of all sealing to be coordinated with council staff.



	п	392	KFI		IVIL	04/2023	
	G	EPA	RFI		ML	02/2022	
	F	EPA	RFI		ML	02/2023	
	Е	EPA	RFI		ML	10/2022	
	Rev	Desc	ription		Ву	Date	
			Ву	Date			
	Surve	y	SURVEYWORX	12/202	12/2021		
	Design Drawn		JV	01/2022			
			MS	02/2022			
	Check	ed	JP	02/20	22		



62, 78 & 80 PAPAKURA -CLEVEDON ROAD, CLEVEDON, AUCKLAND FOR CLEVEDON PROPERTIES LTD

PROPOSED STORMWATER DRAINAGE

LONG SECTIONS


Project no.	194006				
Scale	1:1000 @ A3				
Cad file	C400- DRAINAGE.DWG				
Drawing no.	C423	Rev	Н		



BUN60399307

Approved Resource Consent Plan


01/09/2023

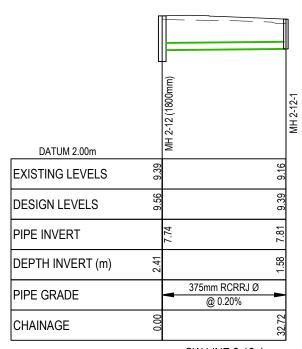


SW LINE 2-12-1 SCALE: HORI 1:1000 VERT 1:200

DATUM 3.00m		MH 2-15 (1800mm)	MH 2-15-1	MH 2-15-2
EXISTING LEVELS	9.84	68.6		9.59
DESIGN LEVELS	10.34	10.37		10.82
PIPE INVERT		8.47	8.54	8.99
DEPTH INVERT (m)	2.33	1.91		1.84
PIPE GRADE	45	0mm RCRRJ @ 0.40%	Ø 375mm RCRRJ Ø @ 0.50%	-
CHAINAGE	0.00	14.01		103.78

SW LINE 2-15-1 SCALE: HORI 1:1000 VERT 1:200

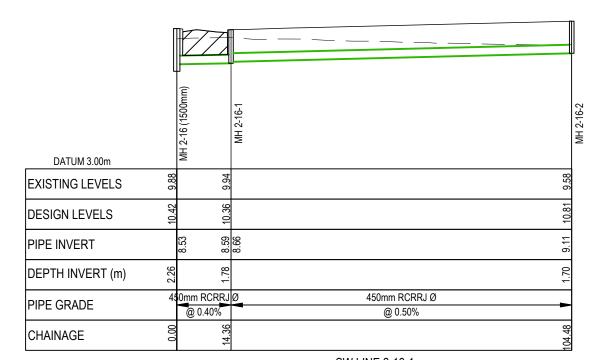

SW LINE 2-16-1 SCALE: HORI 1:1000 VERT 1:200

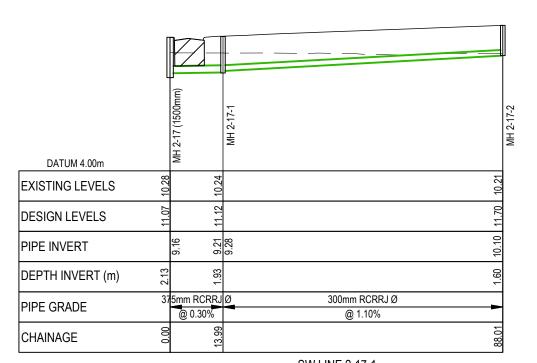

SW LINE 2-17-1 SCALE: HORI 1:1000 VERT 1:200

Notes

- All works to be in accordance with Auckland council standards.
- Co-ordinates in terms of NZ Geodetic Datum Mt Eden 2000. Levels in terms of the Auckland Vertical Datum 1946.
- It is the contractors responsibility to locate all services that may be affected by his operations.
- Pipe bedding: 0 10% granular bedding,10 20% weak concrete bedding.greater than 20% weak concrete bedding (7mpa plus anti scour blocks at 6m crs).
- 5. Each connection shall be marked by a 50mmx50mm treated pine stake extending 600mm above ground level with the top painted This marker post shall be placed alongside a timber marker installed at the time of pipelaying and extending from the connection to 150mm below finished ground level. Connections shall be accurately indicated on "as built" plans.
- Approved hardfill is to be used in backfilling of all road crossings and vehicle crossings to council standards.
- 7. Heavy duty manhole lids and frames to be used in trafficked areas.
- All Manholes are to be 1050mmØ unless shown otherwise.
- Catchpit leads with 800mm or less cover shall be protected with concrete capping.
- All lines to be abandoned shall be sealed at each end. timing of all sealing to be coordinated with council staff.

Legend

EX GROUND LEVEL
PROP FINISHED LEVEL
HARDFILL BACKFILL

	Н	S92	KFI			04/2023
	G	EPA	RFI		ML	02/2022
	F	EPA	RFI		ML	02/2023
	Е	EPA	RFI		ML	10/2022
	Rev Desc		ription		Ву	Date
			Ву	Date		
	Surve	y	SURVEYWORX	12/2021		
	Design Drawn		JV	01/2022		
			MS	02/2022		
	Check	ed	JP	02/20	22	



62, 78 & 80 PAPAKURA -CLEVEDON ROAD, CLEVEDON, AUCKLAND FOR CLEVEDON PROPERTIES LTD

PROPOSED
STORMWATER DRAINAGE

LONG SECTIONS

Project no. 194006


Scale 1:1000 @ A3

Cad file C400- DRAINAGE.DWG


Drawing no. C424 Rev H

Auckland Council Council BUN60399307 Approved Resource Consent Plan 01/09/2023


@ 0.7070	
	90.20
SW LINE 2-18-1 SCALE: HORI 1:1000 VERT 1:200	

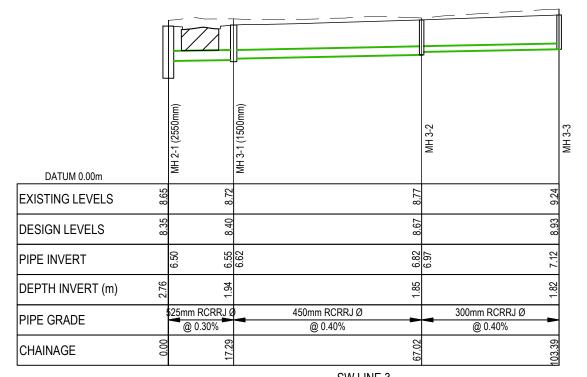

SW LINE 3 SCALE: HORI 1:1000 VERT 1:200

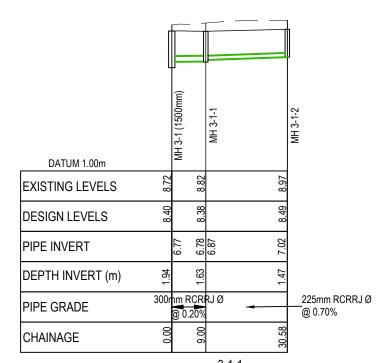

3-1-1 SCALE: HORI 1:1000 VERT 1:200

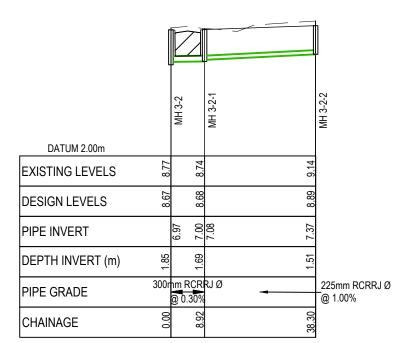

SW LINE 3-2-1 SCALE: HORI 1:1000 VERT 1:200

Note

- All works to be in accordance with Auckland council standards.
- Co-ordinates in terms of NZ Geodetic Datum Mt Eden 2000. Levels in terms of the Auckland Vertical Datum 1946.
- It is the contractors responsibility to locate all services that may be affected by his operations.
- Pipe bedding: 0 10% granular bedding,10 20% weak concrete bedding.greater than 20% weak concrete bedding (7mpa plus anti scour blocks at 6m crs).
- 5. Each connection shall be marked by a 50mmx50mm treated pine stake extending 600mm above ground level with the top painted This marker post shall be placed alongside a timber marker installed at the time of pipelaying and extending from the connection to 150mm below finished ground level. Connections shall be accurately indicated on "as built" plans.
- Approved hardfill is to be used in backfilling of all road crossings and vehicle crossings to council standards.
- 7. Heavy duty manhole lids and frames to be used in trafficked areas.
- All Manholes are to be 1050mmØ unless shown otherwise.
- Catchpit leads with 800mm or less cover shall be protected with concrete capping.
- All lines to be abandoned shall be sealed at each end. timing of all sealing to be coordinated with council staff.

Legend	
	EX GROUND LEVEL PROP FINISHED LEVE HARDFILL BACKFILL

	Н	592	KFI		IVIL	04/2023
	G EPA		RFI		ML	02/2022
	F	EPA	RFI	RFI		02/2023
	Е	EPA	RFI		ML	10/2022
	Rev	Desc	ription		Ву	Date
			Ву	Date		
	Surve	y	SURVEYWORX	12/202	/2021	
	Design Drawn		JV	01/2022		
			MS	02/2022		
	Check	ed	JP	02/2022		





62, 78 & 80 PAPAKURA -

CLEVEDON ROAD,
CLEVEDON, AUCKLAND
FOR CLEVEDON
PROPERTIES LTD


PROPOSED
STORMWATER DRAINAGE
LONG SECTIONS

Project no.	194006		
Scale	1:1000 @ A3		
Cad file	C400- DRAINAGE.DWG		
Drawing no.	C425	Rev	Н

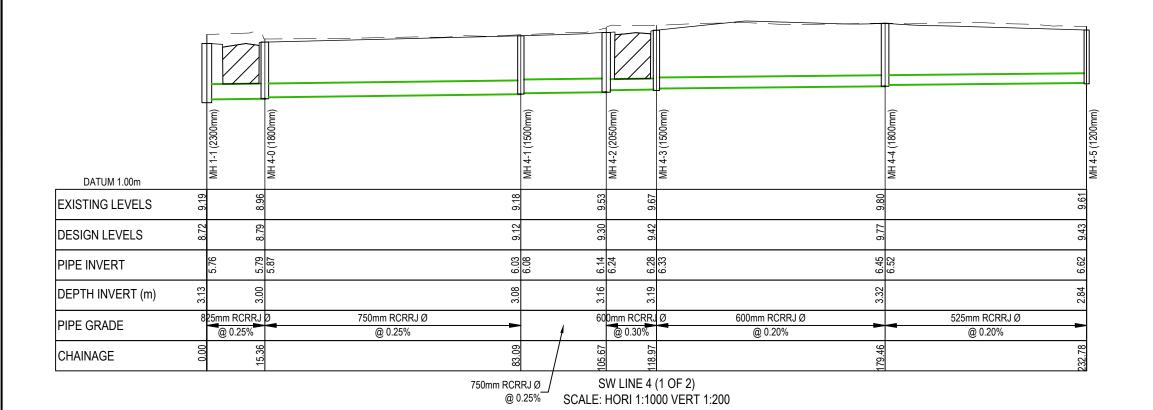

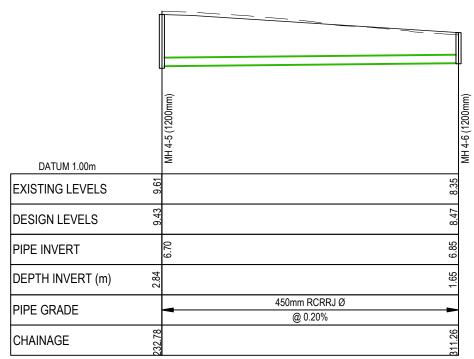

SW LINE 4 (2 OF 2) SCALE: HORI 1:1000 VERT 1:200

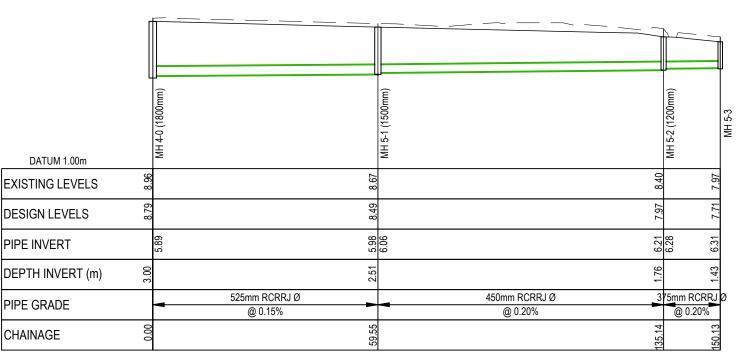

SW LINE 5 SCALE: HORI 1:1000 VERT 1:200

Auckland Council Resource Plan

Approved Resource Consent Plan

01/09/2023

Notes

- All works to be in accordance with Auckland council standards.
- Co-ordinates in terms of NZ Geodetic Datum Mt Eden 2000. Levels in terms of the Auckland Vertical Datum 1946.
- It is the contractors responsibility to locate all services that may be affected by his operations.
- Pipe bedding: 0 10% granular bedding,10 20% weak concrete bedding.greater than 20% weak concrete bedding (7mpa plus anti scour blocks at 6m crs).
- 5. Each connection shall be marked by a 50mmx50mm treated pine stake extending 600mm above ground level with the top painted This marker post shall be placed alongside a timber marker installed at the time of pipelaying and extending from the connection to 150mm below finished ground level. Connections shall be accurately indicated on "as built" plans.
- Approved hardfill is to be used in backfilling of all road crossings and vehicle crossings to council standards.
- Heavy duty manhole lids and frames to be used in trafficked areas.
- All Manholes are to be 1050mmØ unless shown otherwise.
- Catchpit leads with 800mm or less cover shall be protected with concrete capping.
- All lines to be abandoned shall be sealed at each end. timing of all sealing to be coordinated with council staff.

Legend EX GROUND LEVEL PROP FINISHED LEVEL HARDFILL BACKFILL

П	592	KFI		IVIL	04/2023
G EPA		RFI		ML	02/2022
F	EPA	RFI		ML	02/2023
Е	EPA	RFI	RFI		10/2022
Rev	Desc	ription		Ву	Date
		Ву	Date	Date 12/2021	
Surve	у	SURVEYWORX	12/202		
Design Drawn		JV	01/2022		
		MS	02/2022		
Check	ced	JP	02/2022		



62, 78 & 80 PAPAKURA CLEVEDON ROAD,
CLEVEDON, AUCKLAND
FOR CLEVEDON
PROPERTIES LTD


PROPOSED
STORMWATER DRAINAGE
LONG SECTIONS

Project no. 194006


Scale 1:1000 @ A3

Cad file C400- DRAINAGE.DWG

Drawing no. C426 Rev H

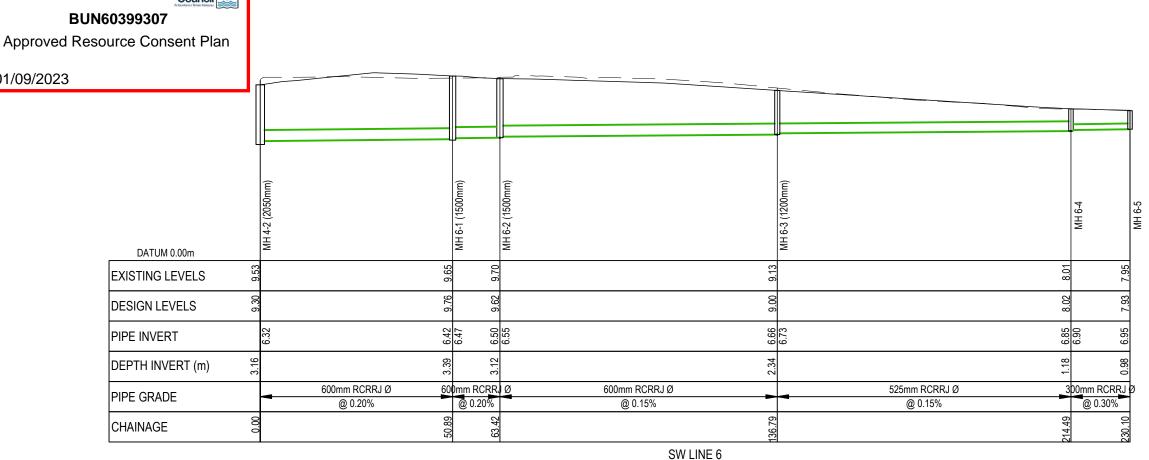

SCALE: HORI 1:1000 VERT 1:200

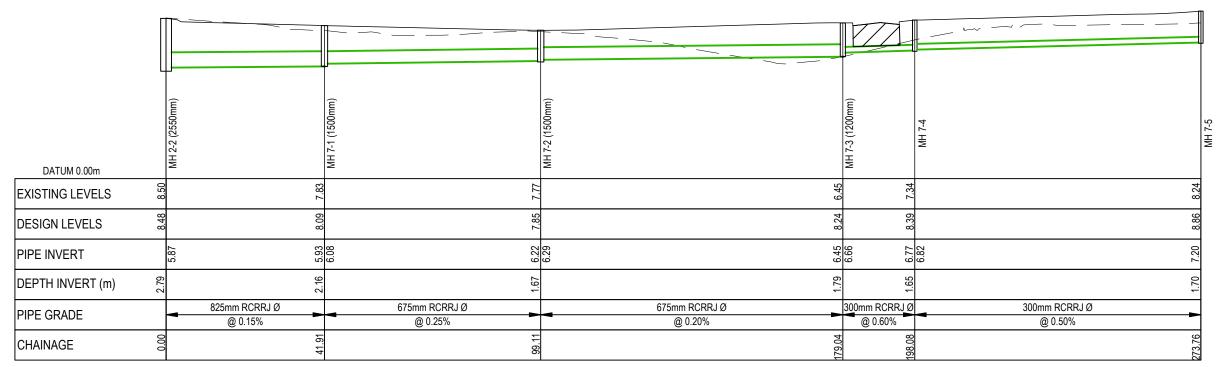

SW LINE 7 SCALE: HORI 1:1000 VERT 1:200

- All works to be in accordance with Auckland council standards.
- Co-ordinates in terms of NZ Geodetic Datum Mt Eden 2000. Levels in terms of the Auckland Vertical Datum 1946.
- It is the contractors responsibility to locate all services that may be affected by his operations.
- Pipe bedding: 0 10% granular bedding,10 -20% weak concrete bedding.greater than 20% weak concrete bedding (7mpa plus anti scour blocks at 6m crs).
- i. Each connection shall be marked by a 50mmx50mm treated pine stake extending 600mm above ground level with the top painted This marker post shall be placed alongside a timber marker installed at the time of pipelaying and extending from the connection to 150mm below finished ground level. Connections shall be accurately indicated on "as built" plans.
- 6. Approved hardfill is to be used in backfilling of all road crossings and vehicle crossings to council standards.
- Heavy duty manhole lids and frames to be used in trafficked areas.
- 3. All Manholes are to be 1050mmØ unless shown
- 9. Catchpit leads with 800mm or less cover shall be protected with concrete capping.
- 10. All lines to be abandoned shall be sealed at each end. timing of all sealing to be coordinated with council staff.



H 5921		592	KFI		IVIL	04/2023
	G EPA		RFI		ML	02/2022
	F	EPA	RFI	RFI		02/2023
	Е	EPA	RFI		ML	10/2022
	Rev	Desc	ription		Ву	Date
			Ву	Date		
	Surve	y	SURVEYWORX	12/202	12/2021	
	Design Drawn		JV	01/2022		
			MS	02/2022		
	Check	ed	JP	02/2022		



62, 78 & 80 PAPAKURA -**CLEVEDON ROAD,** CLEVEDON, AUCKLAND **FOR CLEVEDON PROPERTIES LTD**

PROPOSED STORMWATER DRAINAGE **LONG SECTIONS**

Project no.	194006		
Scale	1:1000 @ A3		
Cad file	C400- DRAINAGE.DWG		
Drawing no.	C427	Rev	Н

RESOURCE CONSENT


01/09/2023

Auckland Council EUN60399307 Approved Resource Consent Plan

SW LINE 7-3-1

SCALE: HORI 1:1000 VERT 1:200

01/09/2023

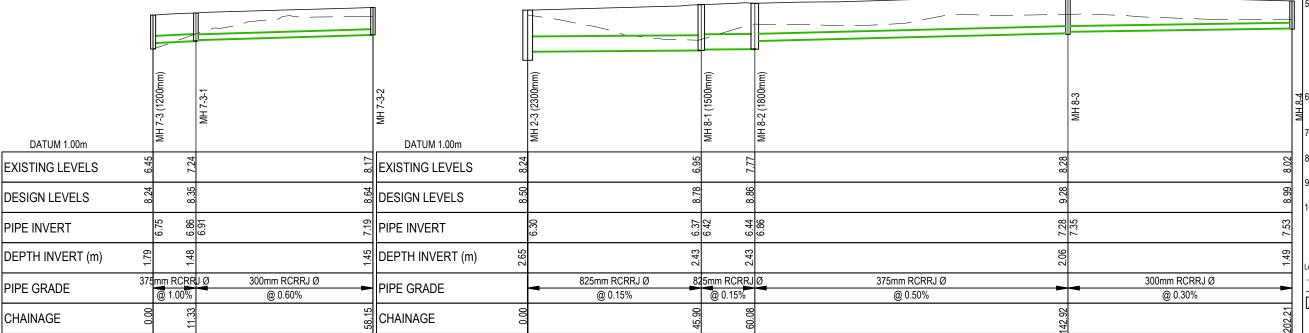

> SW LINE 9 SCALE: HORI 1:1000 VERT 1:200

SW LINE 8

SCALE: HORI 1:1000 VERT 1:200

SW LINE 9-2-1 SCALE: HORI 1:1000 VERT 1:200

Notes

- All works to be in accordance with Auckland council standards.
- Co-ordinates in terms of NZ Geodetic Datum Mt Eden 2000. Levels in terms of the Auckland Vertical Datum 1946.
- Vertical Datum 1946.

 3. It is the contractors responsibility to locate all services that may be affected by his operations.
- Pipe bedding: 0 10% granular bedding,10 -20% weak concrete bedding.greater than 20% weak concrete bedding (7mpa plus anti scour blocks at 6m crs).
- Each connection shall be marked by a 50mmx50mm treated pine stake extending 600mm above ground level with the top painted This marker post shall be placed alongside a timber marker installed at the time of pipelaying and extending from the connection to 150mm below finished ground level. Connections shall be accurately indicated on "as built" plans.
- 76. Approved hardfill is to be used in backfilling of all road crossings and vehicle crossings to council standards.
- 7. Heavy duty manhole lids and frames to be used in trafficked areas.
- All Manholes are to be 1050mmØ unless shown otherwise.
- Catchpit leads with 800mm or less cover shall be protected with concrete capping.
- All lines to be abandoned shall be sealed at each end. timing of all sealing to be coordinated with council staff.

Legend EX GROUND LEVEL PROP FINISHED LEVEL HARDFILL BACKFILL

	G EPAR		RFI		ML	04/2023
			RFI		ML	02/2022
	F	EPA	RFI		ML	02/2023
	Е	EPA	RFI	RFI		10/2022
	Rev	Desc	ription		Ву	Date
			Ву	Date		
	Surve	y	SURVEYWORX	12/202	2/2021	
	Design Drawn		JV	01/2022		
			MS	02/2022		
	Check	ed	JP	02/2022		



62, 78 & 80 PAPAKURA -CLEVEDON ROAD, CLEVEDON, AUCKLAND FOR CLEVEDON

PROPERTIES LTD


Title


PROPOSED
STORMWATER DRAINAGE
LONG SECTIONS

Project no.	194006			
Scale 1:1000 @ A3				
Cad file C400- DRAINAGE.DWG				
Drawing no.	C428	Rev	Н	

Auckland Council
BUN60399307
Approved Resource Consent Plan

01/09/2023

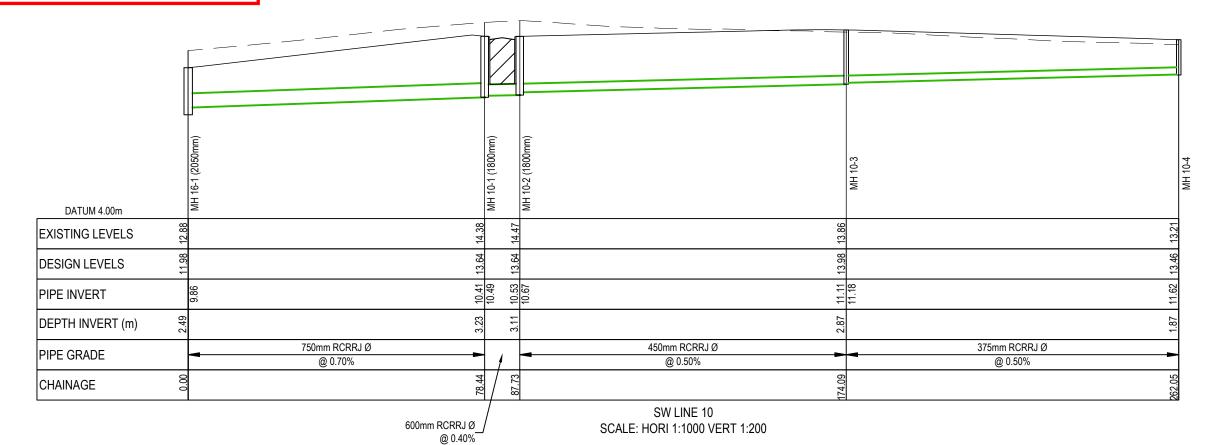

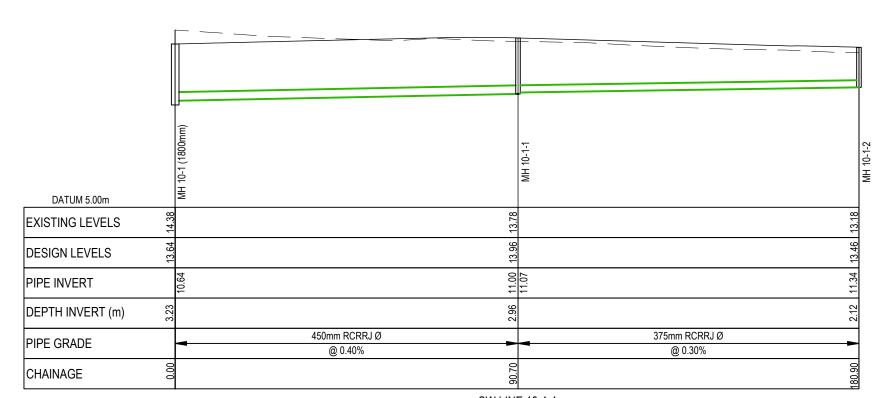

SW LINE 10-1-1 SCALE: HORI 1:1000 VERT 1:200

RESOURCE CONSENT

Notes

- All works to be in accordance with Auckland council standards.
- Co-ordinates in terms of NZ Geodetic Datum Mt Eden 2000. Levels in terms of the Auckland Vertical Datum 1946.
- It is the contractors responsibility to locate all services that may be affected by his operations.
- Pipe bedding: 0 10% granular bedding,10 -20% weak concrete bedding.greater than 20% weak concrete bedding (7mpa plus anti scour blocks at 6m crs).
- 5. Each connection shall be marked by a 50mmx50mm treated pine stake extending 600mm above ground level with the top painted This marker post shall be placed alongside a timber marker installed at the time of pipelaying and extending from the connection to 150mm below finished ground level. Connections shall be accurately indicated on "as built" plans.
- Approved hardfill is to be used in backfilling of all road crossings and vehicle crossings to council standards.
- 7. Heavy duty manhole lids and frames to be used in trafficked areas.
- All Manholes are to be 1050mmØ unless shown otherwise.
- Catchpit leads with 800mm or less cover shall be protected with concrete capping.
- All lines to be abandoned shall be sealed at each end. timing of all sealing to be coordinated with council staff.



G EPA RFI		KFI		IVIL	04/2023		
		EPA	RFI		ML	02/2022	
	F	EPA	RFI		ML	02/2023	
	Е	EPA	RFI		ML	10/2022	
	Rev	Desc	ription		Ву	Date	
			Ву	Date			
	Surve	y	SURVEYWORX	12/202	21		
	Design		JV	01/2022			
	Drawn	1	MS	02/202	22		
	Check	ed	JP	02/2022			



62, 78 & 80 PAPAKURA -CLEVEDON ROAD, CLEVEDON, AUCKLAND FOR CLEVEDON PROPERTIES LTD

PROPOSED
STORMWATER DRAINAGE
LONG SECTIONS


	Project no.	194006			
	Scale	1:1000 @ A3			
Cad file C400- DRAINAGE.DWG					
	Drawing no.	C429	Rev	Н	




BUN60399307

Approved Resource Consent Plan


01/09/2023

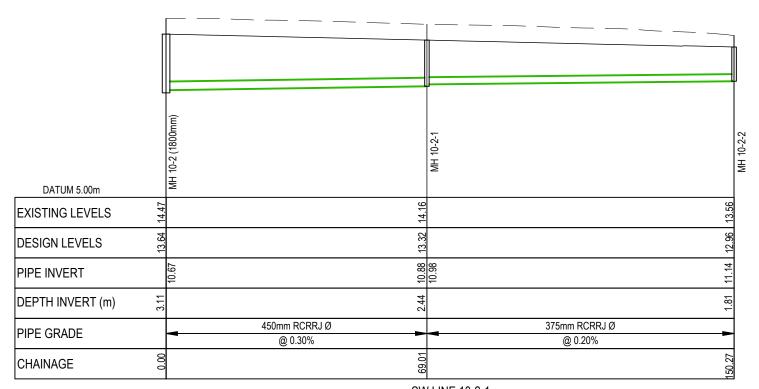

SW LINE 10-2-1 SCALE: HORI 1:1000 VERT 1:200

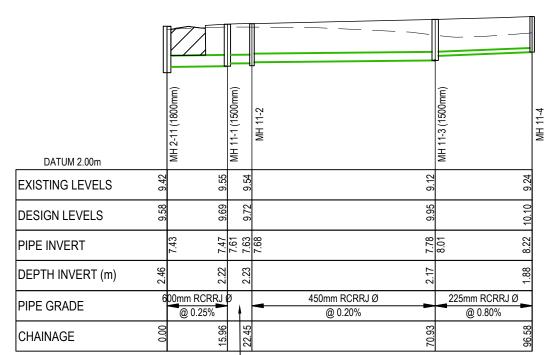

SW LINE 11 SCALE: HORI 1:1000 VERT 1:200

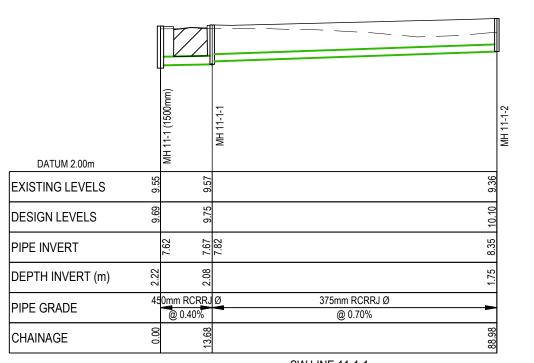

SW LINE 11-1-1 SCALE: HORI 1:1000 VERT 1:200

- All works to be in accordance with Auckland
- Co-ordinates in terms of NZ Geodetic Datum Mt Eden 2000. Levels in terms of the Auckland Vertical Datum 1946.
- It is the contractors responsibility to locate all services that may be affected by his operations.
- Pipe bedding: 0 10% granular bedding,10 -20% weak concrete bedding.greater than 20% weak concrete bedding (7mpa plus anti scour blocks at 6m crs).
- Each connection shall be marked by a 50mmx50mm treated pine stake extending 600mm above ground level with the top painted This marker post shall be placed alongside a timber marker installed at the time of pipelaying and extending from the connection to 150mm below finished ground level. Connections shall be accurately indicated on "as built" plans.
- 6. Approved hardfill is to be used in backfilling of all road crossings and vehicle crossings to council
- Heavy duty manhole lids and frames to be used in trafficked areas.
- . All Manholes are to be 1050mmØ unless shown
- 9. Catchpit leads with 800mm or less cover shall be protected with concrete capping
- 10. All lines to be abandoned shall be sealed at each end. timing of all sealing to be coordinated with council staff.

EX GROUND LEVEL PROP FINISHED LEVEL
HARDFILL BACKFILL


	=	552	INI I		IVIL	04/2023	
	G EF		RFI		ML	02/2022	
	F	EPA	RFI			02/2023	
	Е	EPA	A RFI		ML	10/2022	
	Rev	Desc	ription		Ву	Date	
			Ву	Date	Date 12/2021		
	Surve	y	SURVEYWORX	12/202			
	Design Drawn		JV	01/2022			
			MS	02/2022			
	Check	ed	JP	02/20	22		



62, 78 & 80 PAPAKURA -**CLEVEDON ROAD,** CLEVEDON, AUCKLAND **FOR CLEVEDON PROPERTIES LTD**

PROPOSED **STORMWATER DRAINAGE LONG SECTIONS**

Project no.	194006				
Scale					
Cad file	C400- DRAINAGE.DWG				
Drawing no.	C430	Rev	Н		

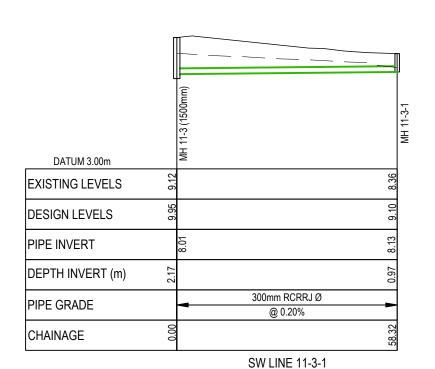

SCALE: HORI 1:1000 VERT 1:200

DATUM 4.00m EXISTING LEVELS DESIGN LEVELS 9.17 PIPE INVERT DEPTH INVERT (m) 1350mm RCRRJ Ø 1350mm RCRRJ Ø 1050mm RCRRJ Ø 900mm RCRRJ Ø PIPE GRADE @ 0.15% @ 0.10% @ 0.10% CHAINAGE SW LINE 12 (1 OF 2)

SCALE: HORI 1:1000 VERT 1:200

DATUM 4.00m EXISTING LEVELS DESIGN LEVELS 9.73 PIPE INVERT 2.63 DEPTH INVERT (m) 750mm RCRRJØ 600mm RCRRJ Ø 450mm RCRRJ Ø 375mm RCRRJ Ø PIPE GRADE @ 0.15% @ 0.20% @ 0.60% CHAINAGE

> SW LINE 12 (2 OF 2) SCALE: HORI 1:1000 VERT 1:200

BUN60399307
Approved Resource Consent Plan
01/09/2023

Notes

- All works to be in accordance with Auckland council standards.
- Co-ordinates in terms of NZ Geodetic Datum Mt Eden 2000. Levels in terms of the Auckland Vertical Datum 1046
- Vertical Datum 1946.

 It is the contractors responsibility to locate all services that may be affected by his operations.
- Pipe bedding: 0 10% granular bedding,10 -20% weak concrete bedding.greater than 20% weak concrete bedding (7mpa plus anti scour blocks at 6m crs).
- Each connection shall be marked by a 50mmx50mm treated pine stake extending 600mm above ground level with the top painted This marker post shall be placed alongside a timber marker installed at the time of pipelaying and extending from the connection to 150mm below finished ground level. Connections shall be accurately indicated on "as built" plans.
- Approved hardfill is to be used in backfilling of all road crossings and vehicle crossings to council standards.
- 7. Heavy duty manhole lids and frames to be used in trafficked areas.
- All Manholes are to be 1050mmØ unless shown otherwise.
- otherwise.

 9. Catchpit leads with 800mm or less cover shall be

protected with concrete capping.

 All lines to be abandoned shall be sealed at each end. timing of all sealing to be coordinated with council staff.

Legend

EX GROUND LEVEL

PROP FINISHED LEVEL

HARDFILL BACKFILL

Н	S92 RFI			ML	04/2023
G	EPA RFI			ML	02/2022
F	EPA	EPA RFI		ML	02/2023
Е	EPA	RFI	ML	10/2022	
Rev	Desc	ription		Ву	Date
	Ву		Date		
Surve	y	SURVEYWORX	12/2021		
Design		JV	01/2022		
Drawn	1	MS	02/2022		
Check	ed	JP	02/20	22	



62, 78 & 80 PAPAKURA CLEVEDON ROAD,
CLEVEDON, AUCKLAND
FOR CLEVEDON
PROPERTIES LTD


PROPOSED
STORMWATER DRAINAGE
LONG SECTIONS

Project no. 194006


Scale 1:1000 @ A3

Cad file C400- DRAINAGE.DWG


Drawing no. C431 Rev H

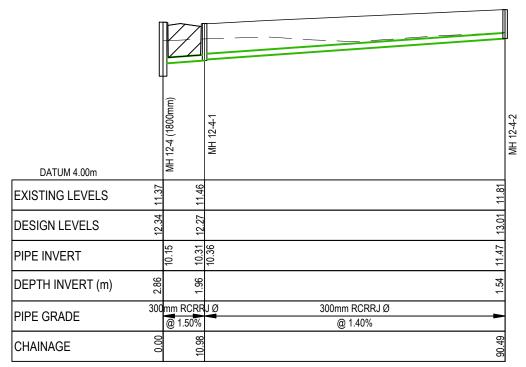

SW LINE 12-4-1 SCALE: HORI 1:1000 VERT 1:200

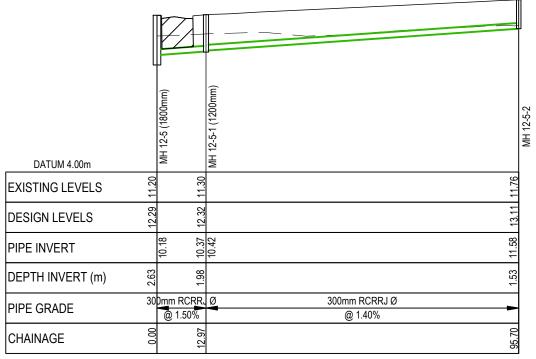

SW LINE 12-5-1 SCALE: HORI 1:1000 VERT 1:200

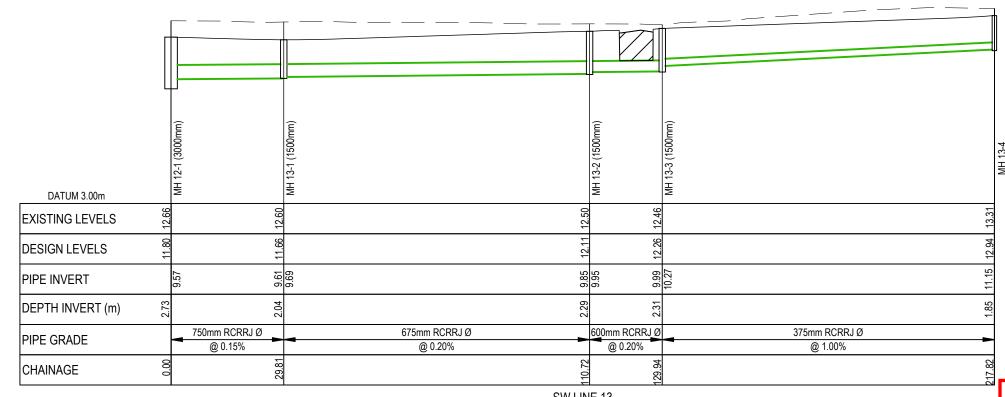

SW LINE 13

SCALE: HORI 1:1000 VERT 1:200

RESOURCE CONSENT

Auckland Council BUN60399307 Approved Resource Consent Plan

01/09/2023

- All works to be in accordance with Auckland council standards.
- Co-ordinates in terms of NZ Geodetic Datum Mt Eden 2000. Levels in terms of the Auckland Vertical Datum 1946.
- It is the contractors responsibility to locate all services that may be affected by his operations.
- Pipe bedding: 0 10% granular bedding,10 -20% weak concrete bedding.greater than 20% weak concrete bedding (7mpa plus anti scour blocks at 6m crs).
- Each connection shall be marked by a 50mmx50mm treated pine stake extending 600mm above ground level with the top painted This marker post shall be placed alongside a timber marker installed at the time of pipelaying and extending from the connection to 150mm below finished ground level. Connections shall be accurately indicated on "as built" plans.
- Approved hardfill is to be used in backfilling of all road crossings and vehicle crossings to council standards.
- Heavy duty manhole lids and frames to be used in trafficked areas.
- All Manholes are to be 1050mmØ unless shown
- Catchpit leads with 800mm or less cover shall be protected with concrete capping.
- 10. All lines to be abandoned shall be sealed at each end. timing of all sealing to be coordinated with council staff.

EX GROUND LEVEL PROP FINISHED LEVEL
HARDFILL BACKFILL


Н	S92	RFI		ML	04/2023	
G	EPA	RFI	ML	02/2022		
F	EPA	RFI		ML	02/2023	
Е	EPA	RFI	ML	10/2022		
Rev	Desc	escription		Ву	Date	
		Ву	Date	Date		
Surve	у	SURVEYWORX	12/2021			
Design Drawn Checked		JV	01/2022 02/2022			
		MS				
		JP	02/20	22	,	



62, 78 & 80 PAPAKURA -**CLEVEDON ROAD, CLEVEDON, AUCKLAND FOR CLEVEDON PROPERTIES LTD**

PROPOSED **STORMWATER DRAINAGE** LONG SECTIONS

194006 Project no. 1:1000 @ A3 C400- DRAINAGE.DWG

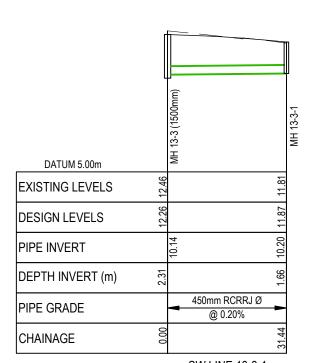

SW LINE 13-3-1 SCALE: HORI 1:1000 VERT 1:200

DATUM 4.00m	MH 12-2 (2550mm)	1-41	MH 14-2 (1500mm)	MH 14-3 (1500mm)
	5 5	2.49	5 53	2.84
DESIGN LEVELS	12 02		75.55	75.27
PIPE INVERT	9.57	9.65	9.77	9.90
DEPTH INVERT (m)	2 49	2.55	2.70	2.94
PIPE GRADE	825mm RCRRJ @ 0.15%	825mm RCRRJ Ø @ 0.15%	825mm RCRRJ Ø @ 0.15%	750mm RCRRJ Ø @ 0.15%
CHAINAGE S	0 0	69,09	80	

SW LINE 14 (1 OF 2) SCALE: HORI 1:1000 VERT 1:200

DATUM 5.00m		MH 14-4 (1500mm)	MH 14-5 (1500mm)			MH 14-6 (1500mm)	MH 14-7 (1200mm)			MH 14-8
EXISTING LEVELS	12.84	12.81			12.39	12.35			12.28	
DESIGN LEVELS	12.97	13.10			12.75	75	2		12.37	
PIPE INVERT	Ç	10.12	10.19		10.33	10.58	10.65		10.85	
DEPTH INVERT (m)	2.94	2.96			2.48	2.23			1.54	
PIPE GRADE	675m	m RCRI 0.20%	ĸJØ	675mm RCRRJ Ø @ 0.20%	450	mm RCRF @ 0.30%		375mm RCRRJ Ø @ 0.30%	_	
CHAINAGE	200.67	210.40			282.42	0.5	_		361.45	

SW LINE 14 (2 OF 2) SCALE: HORI 1:1000 VERT 1:200

BUN60399307
Approved Resource Consent Plan

01/09/2023

Auckland Council

Notes

- All works to be in accordance with Auckland council standards.
- Co-ordinates in terms of NZ Geodetic Datum Mt
 Eden 2000. Levels in terms of the Auckland
 Vertical Datum 1006.
- Vertical Datum 1946.
 It is the contractors responsibility to locate all services that may be affected by his operations.
- Pipe bedding: 0 10% granular bedding;10 -20% weak concrete bedding.greater than 20% weak concrete bedding (7mpa plus anti scour blocks at 6m crs).
- 5. Each connection shall be marked by a 50mmx50mm treated pine stake extending 600mm above ground level with the top painted. This marker post shall be placed alongside a timber marker installed at the time of pipelaying and extending from the connection to 150mm below finished ground level. Connections shall be accurately indicated on "as built" plans.
- Approved hardfill is to be used in backfilling of all road crossings and vehicle crossings to council standards.
- 7. Heavy duty manhole lids and frames to be used in trafficked areas.
- All Manholes are to be 1050mmØ unless shown otherwise.
- Catchpit leads with 800mm or less cover shall be protected with concrete capping.
- All lines to be abandoned shall be sealed at each end. timing of all sealing to be coordinated with council staff.



	Н	S92 RFI			ML	04/2023	
	G	EPA RFI			ML	02/2022	
	F	EPA	RFI	ML	02/2023		
	Е	EPA	RFI	ML	10/2022		
	Rev	Desc	cription		Ву	Date	
		Ву		Date			
	Survey Design		SURVEYWORX	12/202	21		
			JV	01/2022			
	Drawn	1	MS	02/2022			
	Check	ed	JP	02/20	22		



62, 78 & 80 PAPAKURA -CLEVEDON ROAD, CLEVEDON, AUCKLAND FOR CLEVEDON PROPERTIES LTD


PROPOSED
STORMWATER DRAINAGE
LONG SECTIONS

Project no. 194006

Scale 1:1000 @ A3

Cad file C400- DRAINAGE.DWG

Drawing no. C433 Rev H

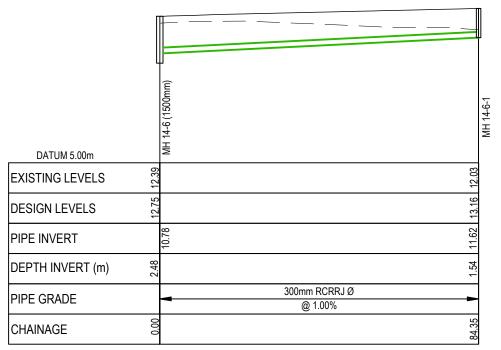

SW LINE 14-6-1 SCALE: HORI 1:1000 VERT 1:200



SW LINE 14-7-1 SCALE: HORI 1:1000 VERT 1:200

> SW LINE 15 SCALE: HORI 1:1000 VERT 1:200

RESOURCE CONSENT




BUN60399307

Approved Resource Consent Plan

01/09/2023

4 411

- All works to be in accordance with Auckland council standards
- Co-ordinates in terms of NZ Geodetic Datum Mt Eden 2000. Levels in terms of the Auckland Vertical Datum 1946.
- It is the contractors responsibility to locate all services that may be affected by his operations.
- Pipe bedding: 0 10% granular bedding,10 -20% weak concrete bedding.greater than 20% weak concrete bedding (7mpa plus anti scour blocks at 6m crs).
- Each connection shall be marked by a 50mmx50mm treated pine stake extending 600mm above ground level with the top painted. This marker post shall be placed alongside a timber marker installed at the time of pipelaying and extending from the connection to 150mm below finished ground level. Connections shall be accurately indicated on "as built" plans.
- Approved hardfill is to be used in backfilling of all road crossings and vehicle crossings to council standards.
- 7. Heavy duty manhole lids and frames to be used in trafficked areas.
- All Manholes are to be 1050mmØ unless shown otherwise
- Catchpit leads with 800mm or less cover shall be protected with concrete capping.
- All lines to be abandoned shall be sealed at each end. timing of all sealing to be coordinated with council staff.

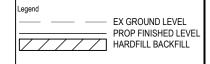

Н	S92 RFI			ML	04/2023	
G	EPA	EPA RFI			02/2022	
F	EPA	EPA RFI		ML	02/2023	
Е	EPA	RFI	ML	10/2022		
Rev	Desc	ription		Ву	Date	
	Ву		Date	Date		
Surve	ey SURVEYWORX		12/2021			
Desig	1	JV	01/2022			
Drawn	1	MS	02/2022			
Check	ed	JP	02/2022			



62, 78 & 80 PAPAKURA - CLEVEDON ROAD, CLEVEDON, AUCKLAND FOR CLEVEDON PROPERTIES LTD

PROPOSED
STORMWATER DRAINAGE


LONG SECTIONS

 Project no.
 194006

 Scale
 1:1000 @ A3

 Cad file
 C400- DRAINAGE.DWG

 Drawing no.
 C434
 Rev
 H

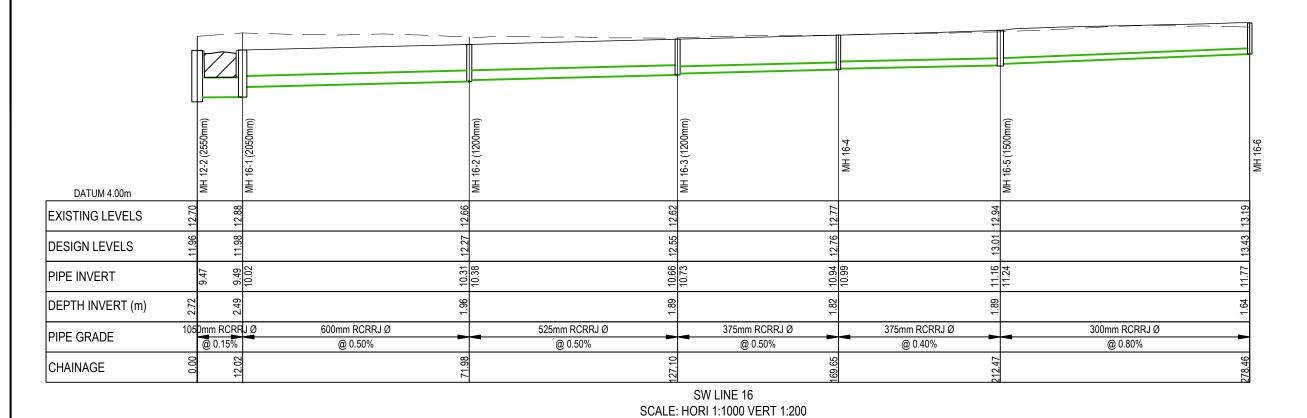

DATUM 4.00m

EXISTING LEVELS

DESIGN LEVELS

DESIGN LEVELS

PIPE INVERT

DEPTH INVERT (m)

DEPTH INVERT (m)

DEPTH INVERT (m)

EXECUTE 100 (m)

SW LINE 17

SCALE: HORI 1:1000 VERT 1:200

Auckland Council
Council
BUN60399307

Approved Resource Consent Plan
01/09/2023

Notes

- All works to be in accordance with Auckland council standards.
- Co-ordinates in terms of NZ Geodetic Datum Mt Eden 2000. Levels in terms of the Auckland Vertical Datum 1946.
- It is the contractors responsibility to locate all services that may be affected by his operations.
- Pipe bedding: 0 10% granular bedding,10 20% weak concrete bedding.greater than 20% weak concrete bedding (7mpa plus anti scour blocks at 6m crs).
- 5. Each connection shall be marked by a 50mmx50mm treated pine stake extending 600mm above ground level with the top painted This marker post shall be placed alongside a timber marker installed at the time of pipelaying and extending from the connection to 150mm below finished ground level. Connections shall be accurately indicated on "as built" plans.
- Approved hardfill is to be used in backfilling of all road crossings and vehicle crossings to council standards.
- 7. Heavy duty manhole lids and frames to be used in trafficked areas.
- All Manholes are to be 1050mmØ unless shown otherwise.
- Catchpit leads with 800mm or less cover shall be protected with concrete capping.
- All lines to be abandoned shall be sealed at each end. timing of all sealing to be coordinated with council staff.



	111	332	IXI I		IVIL	04/2023
	G	EPA RFI			ML	02/2022
	F	EPA	RFI	ML	02/2023	
	Е	EPA RFI			ML	10/2022
	Rev	Desc	ription		Ву	Date
			Ву	Date		
	Survey Design Drawn Checked		SURVEYWORX	12/2021 01/2022		
			JV			
			MS	02/2022		
			JP	02/2022		



62, 78 & 80 PAPAKURA CLEVEDON ROAD,
CLEVEDON, AUCKLAND
FOR CLEVEDON
PROPERTIES LTD

PROPOSED
STORMWATER DRAINAGE
LONG SECTIONS

 Project no.
 194006

 Scale
 1:1000 @ A3

 Cad file
 C400- DRAINAGE.DWG

 Drawing no.
 C435
 Rev
 H

RESOURCE CONSENT

600mm RCRRJ Ø

@ 0.15%


DATUM 3.00m EXISTING LEVELS DESIGN LEVELS PIPE INVERT DEPTH INVERT (m) PIPE GRADE CHAINAGE On the second of the second of

SW LINE 20


SCALE: HORI 1:1000 VERT 1:200

DATUM 0.00m EXISTING LEVELS DESIGN LEVELS PIPE INVERT DEPTH INVERT (m) PIPE GRADE CHAINAGE CHAINAGE

SW LINE 21 SCALE: HORI 1:1000 VERT 1:200

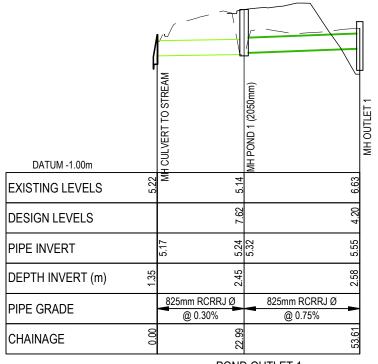

POND OUTLET 1 SCALE: HORI 1:1000 VERT 1:200

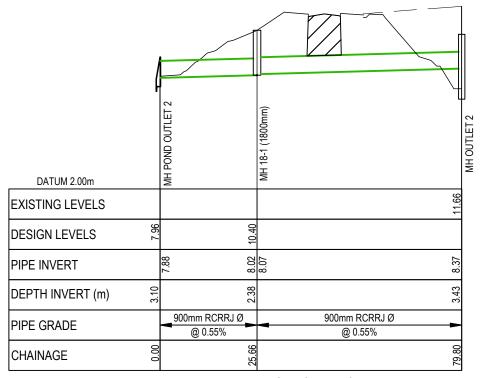

POND OUTLET 2 SCALE: HORI 1:1000 VERT 1:200

Note

Auckland Council

BUN60399307

Approved Resource Consent Plan

01/09/2023

- All works to be in accordance with Auckland council standards.
 - Co-ordinates in terms of NZ Geodetic Datum Mt Eden 2000. Levels in terms of the Auckland Vertical Datum 1946.
 - It is the contractors responsibility to locate all services that may be affected by his operations.
 - Pipe bedding: 0 10% granular bedding,10 -20% weak concrete bedding.greater than 20% weak concrete bedding (7mpa plus anti scour blocks at 6m crs).
 - 5. Each connection shall be marked by a 50mmx50mm treated pine stake extending 600mm above ground level with the top painted This marker post shall be placed alongside a timber marker installed at the time of pipelaying and extending from the connection to 150mm below finished ground level. Connections shall be accurately indicated on "as built" plans.
 - Approved hardfill is to be used in backfilling of all road crossings and vehicle crossings to council standards.
 - Heavy duty manhole lids and frames to be used in trafficked areas.
 - All Manholes are to be 1050mmØ unless shown otherwise.
 - Catchpit leads with 800mm or less cover shall be protected with concrete capping.

 All lines to be absorbed shall be seeled at each
 - All lines to be abandoned shall be sealed at each end. timing of all sealing to be coordinated with council staff.

Legend	
	EX GROUND LEVEL PROP FINISHED LEVEL HARDFILL BACKFILL

Н	H S92 RFI G EPA RFI		ML	04/2023	
G			ML	02/2022	
F	EPA	RFI		ML	02/2023
Е	EPA RFI Description		ML	10/2022	
Rev				Ву	Date
		Ву	Date	Date 12/2021	
Surve	у	SURVEYWORX	12/20		
Design Drawn		JV	01/20	01/2022	
		MS	02/20	22	·
Check	ced	JP	02/20	02/2022	




62, 78 & 80 PAPAKURA - CLEVEDON ROAD, CLEVEDON, AUCKLAND FOR CLEVEDON PROPERTIES LTD

PROPOSED
STORMWATER DRAINAGE
LONG SECTIONS


Project no.	194006		
Scale	1:1000 @ A3		
Cad file	ad file C400- DRAINAGE.DWG		
Drawing no.	C436	Rev	Н

RESOURCE CONSENT

Auckland Council
BUN60399307
Approved Resource Consent Plan
01/09/2023

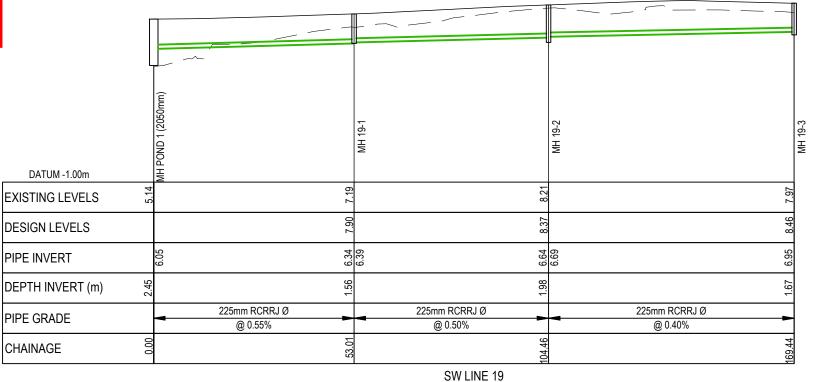

SCALE: HORI 1:1000 VERT 1:200

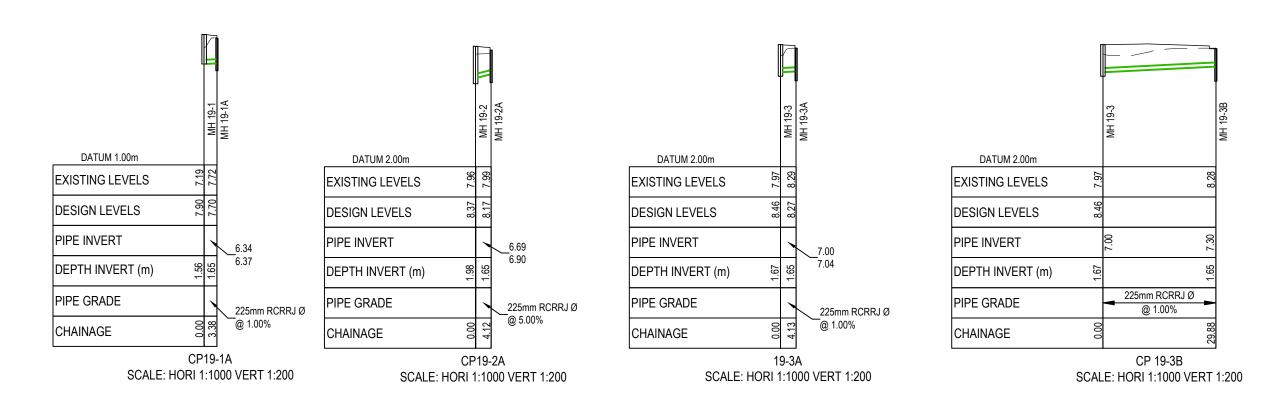

Notes

- All works to be in accordance with Auckland council standards.
- Co-ordinates in terms of NZ Geodetic Datum Mt Eden 2000. Levels in terms of the Auckland Vertical Datum 1946.
- It is the contractors responsibility to locate all services that may be affected by his operations.
- Pipe bedding: 0 10% granular bedding,10 20% weak concrete bedding.greater than 20% weak concrete bedding (7mpa plus anti scour blocks at 6m crs).
- 5. Each connection shall be marked by a 50mmx50mm treated pine stake extending 600mm above ground level with the top painted This marker post shall be placed alongside a timber marker installed at the time of pipelaying and extending from the connection to 150mm below finished ground level. Connections shall be accurately indicated on "as built" plans.
- Approved hardfill is to be used in backfilling of all road crossings and vehicle crossings to council standards.
- Heavy duty manhole lids and frames to be used in trafficked areas.
- All Manholes are to be 1050mmØ unless showr otherwise.
- Catchpit leads with 800mm or less cover shall be protected with concrete capping.
- All lines to be abandoned shall be sealed at each end. timing of all sealing to be coordinated with council staff.

Legend

EX GROUND LEVEL

PROP FINISHED LEVEL

HARDFILL BACKFILL

	H S92 RFI G EPA RFI			ML	04/2023	
			ML	02/2022		
	F	EPA RFI		ML	02/2023	
	Е	E EPA RFI			ML	10/2022
	Rev Desc		ription		Ву	Date
			Ву	Date	1	
	Surve	y	SURVEYWORX	12/2021		
	Design Drawn		JV	01/2022		·
			MS	02/202	22	·
	Check	ed	JP	02/20	22	_



62, 78 & 80 PAPAKURA CLEVEDON ROAD,
CLEVEDON, AUCKLAND
FOR CLEVEDON
PROPERTIES LTD

PROPOSED
STORMWATER DRAINAGE
LONG SECTIONS


Project no. 194006


Scale 1:1000 @ A3

Cad file C400- DRAINAGE.DWG

Drawing no. C437 Rev H

RESOURCE CONSENT

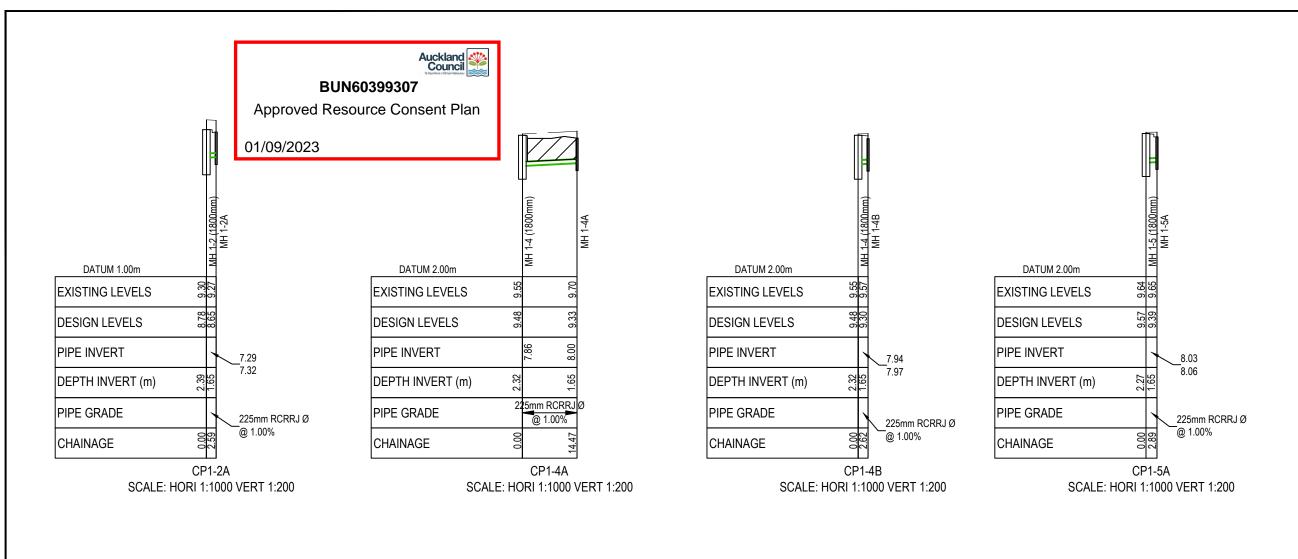

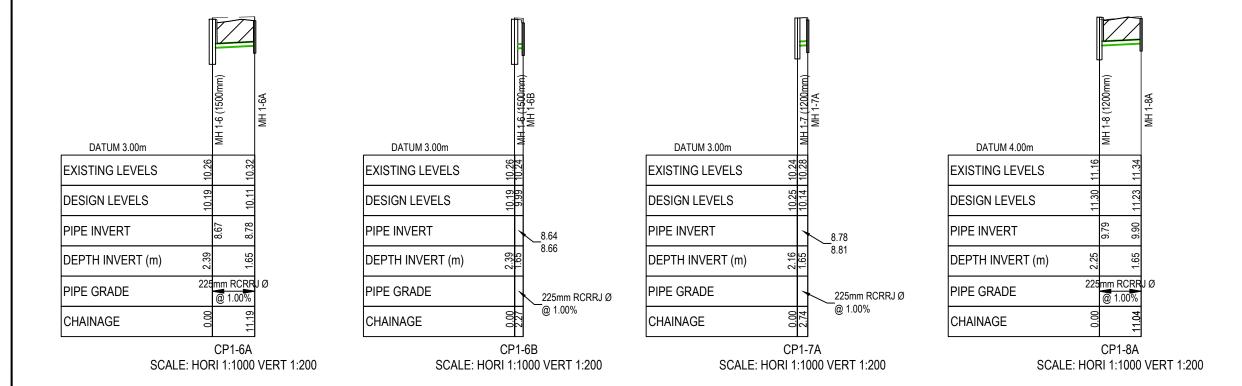

- All works to be in accordance with Auckland
- Co-ordinates in terms of NZ Geodetic Datum Mt Eden 2000. Levels in terms of the Auckland Vertical Datum 1946.
- It is the contractors responsibility to locate all services that may be affected by his operations.
- Pipe bedding: 0 10% granular bedding,10 -20% weak concrete bedding.greater than 20% weak concrete bedding (7mpa plus anti scour blocks at 6m crs).
- Each connection shall be marked by a 50mmx50mm treated pine stake extending 600mm above ground level with the top painted This marker post shall be placed alongside a timber marker installed at the time of pipelaying and extending from the connection to 150mm below finished ground level. Connections shall be accurately indicated on "as built" plans.
- Approved hardfill is to be used in backfilling of all road crossings and vehicle crossings to council
- Heavy duty manhole lids and frames to be used in trafficked areas.
- All Manholes are to be 1050mmØ unless shown
- . Catchpit leads with 800mm or less cover shall be protected with concrete capping
- 0. All lines to be abandoned shall be sealed at each end. timing of all sealing to be coordinated with council staff.



Н				ML	04/2023	
G					02/2022	
F	EPA	RFI		ML	02/2023	
Е	EPA RFI			ML	10/2022	
Rev	Desc	Description		Ву	Date	
		Ву	Date)		
Surve	y	SURVEYWORX	12/20	12/2021		
Design Drawn		JV	01/20	01/2022		
		MS	02/20	22	•	
Check	ked	JP	02/20	22		





62, 78 & 80 PAPAKURA -**CLEVEDON ROAD, CLEVEDON, AUCKLAND** FOR CLEVEDON **PROPERTIES LTD**

PROPOSED STORMWATER DRAINAGE LONG SECTIONS

Project no.	194006		
Scale	1:1000 @ A3		
Cad file	C400- DRAINAGE.DWG		
Drawing no.	C437A	Rev	Н

RESOURCE CONSENT

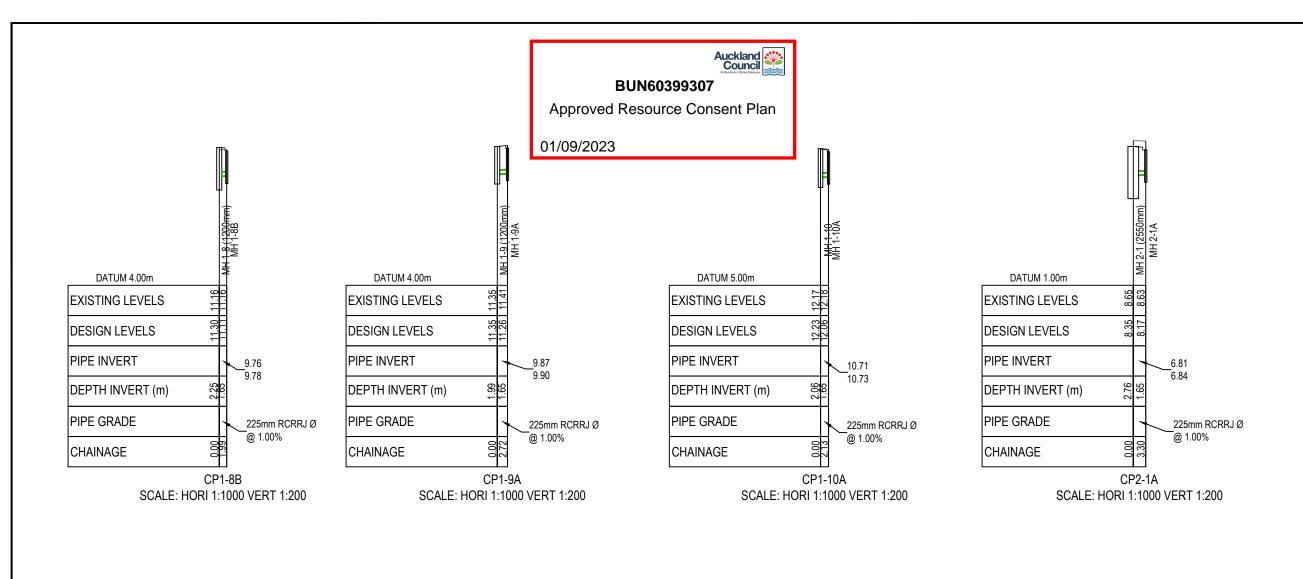

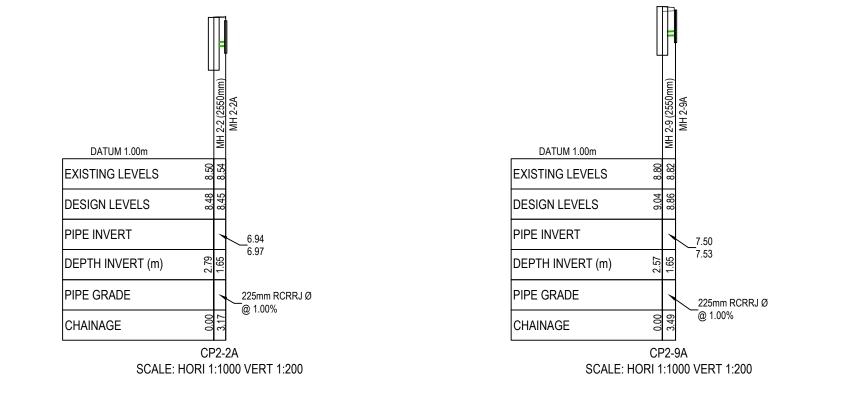

Note

- All works to be in accordance with Auckland council standards.
- Co-ordinates in terms of NZ Geodetic Datum Mt Eden 2000. Levels in terms of the Auckland Vertical Datum 1946.
- It is the contractors responsibility to locate all services that may be affected by his operations.
- Pipe bedding: 0 10% granular bedding,10 20% weak concrete bedding.greater than 20% weak concrete bedding (7mpa plus anti scour blocks at 6m crs).
- 5. Each connection shall be marked by a 50mmx50mm treated pine stake extending 600mm above ground level with the top painted This marker post shall be placed alongside a timber marker installed at the time of pipelaying and extending from the connection to 150mm below finished ground level. Connections shall be accurately indicated on "as built" plans.
- Approved hardfill is to be used in backfilling of all road crossings and vehicle crossings to council standards.
- Heavy duty manhole lids and frames to be used in trafficked areas.
- All Manholes are to be 1050mmØ unless showr otherwise.
- Catchpit leads with 800mm or less cover shall be protected with concrete capping.
- All lines to be abandoned shall be sealed at each end. timing of all sealing to be coordinated with council staff.

EX GROUND LEVEL
PROP FINISHED LEVEL
HARDFILL BACKFILL

Н	S92	RFI		ML	04/2023	
G	F EPA RFI E EPA RFI			ML	02/2022	
F					02/2023	
Е				ML	10/2022	
Rev				Ву	Date	
		Ву	Date	Date		
Survey Design Drawn		SURVEYWORX	12/20	12/2021		
		JV	01/20	01/2022 02/2022		
		MS	02/20			
Chec	ked	JP	02/20	02/2022		



Project

62, 78 & 80 PAPAKURA -CLEVEDON ROAD, CLEVEDON, AUCKLAND FOR CLEVEDON PROPERTIES LTD

PROPOSED
STORMWATER DRAINAGE
LONG SECTIONS

	Project no.	194006		
	Scale	1:1000 @ A3		
Cad file C400- DRAINAGE.DWG				
	Drawing no.	C437B	Rev	Н

RESOURCE CONSENT

DATUM 5.00m

EXISTING LEVELS

DESIGN LEVELS

DEPTH INVERT (m)

PIPE INVERT

PIPE GRADE


CHAINAGE


MH 1-10B

225mm RCRRJ Ø @ 1.00%


CP1-10B

SCALE: HORI 1:1000 VERT 1:200

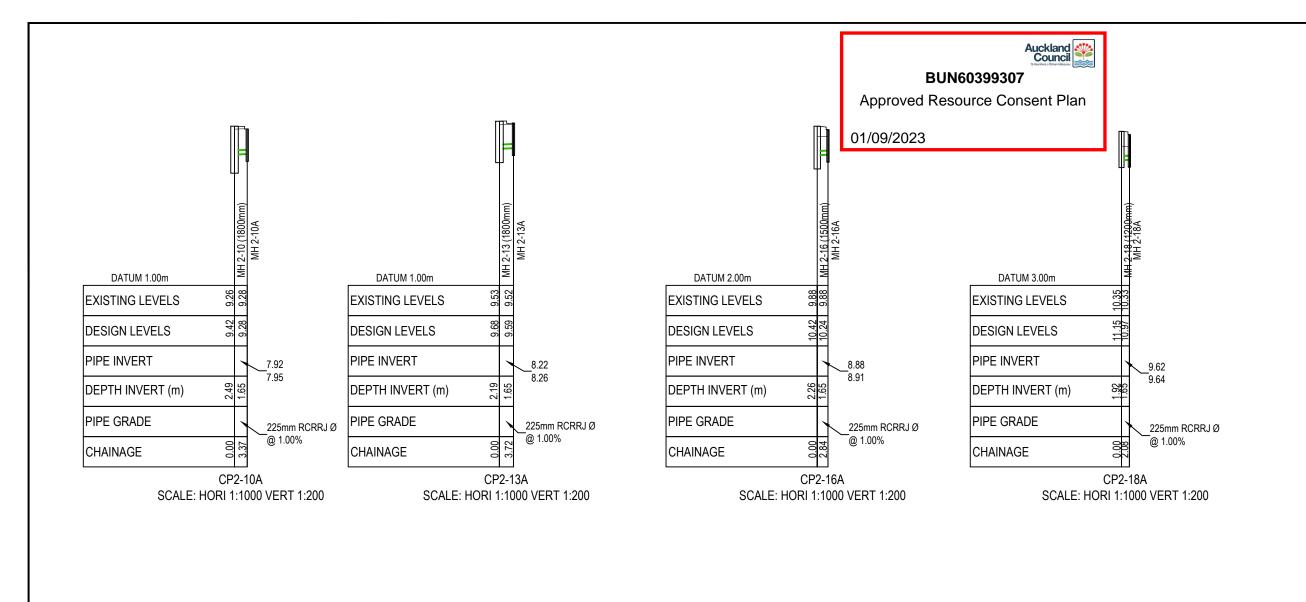

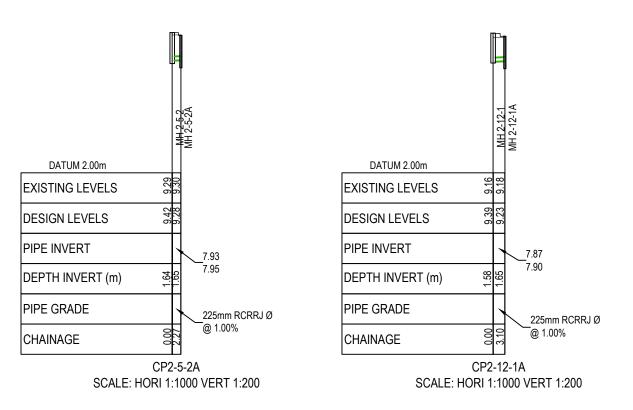

- All works to be in accordance with Auckland council standards.
- Co-ordinates in terms of NZ Geodetic Datum Mt Eden 2000. Levels in terms of the Auckland Vertical Datum 1946.
- It is the contractors responsibility to locate all services that may be affected by his operations.
- Pipe bedding: 0 10% granular bedding,10 -20% weak concrete bedding.greater than 20% weak concrete bedding (7mpa plus anti scour blocks at 6m crs).
- Each connection shall be marked by a 50mmx50mm treated pine stake extending 600mm above ground level with the top painted This marker post shall be placed alongside a timber marker installed at the time of pipelaying and extending from the connection to 150mm below finished ground level. Connections shall be accurately indicated on "as built" plans.
- Approved hardfill is to be used in backfilling of all road crossings and vehicle crossings to council standards.
- Heavy duty manhole lids and frames to be used in trafficked areas.
- All Manholes are to be 1050mmØ unless shown
- Catchpit leads with 800mm or less cover shall be protected with concrete capping.
- 0. All lines to be abandoned shall be sealed at each end. timing of all sealing to be coordinated with council staff.

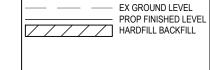

G	-			ML	02/2022
F			ML	02/2023	
Е	EPA	RFI		ML	10/2022
Rev	Desc	cription		Ву	Date
		Ву	Date		
Surve	y	SURVEYWORX	12/202	12/2021	
Design	n	JV	01/2022		
Drawn		MS	02/2022		
Check	ed	JP	02/20	22	

ML 04/2023



H S92 RFI

62, 78 & 80 PAPAKURA -**CLEVEDON ROAD, CLEVEDON, AUCKLAND** FOR CLEVEDON **PROPERTIES LTD**

PROPOSED

STORMWATER DRAINAGE **LONG SECTIONS**

Project no.	194006			
Scale	1:1000 @ A3			
Cad file	C400- DRAINAGE.DWG			
Drawing no.	C437C	Rev	Н	

RESOURCE CONSENT

DATUM 4.00m

EXISTING LEVELS

DESIGN LEVELS

DEPTH INVERT (m)

PIPE INVERT

PIPE GRADE

CHAINAGE

DATUM 1.00m

7.56

7.58

225mm RCRRJ Ø

__@ 1.00%

CP2-5-1A

SCALE: HORI 1:1000 VERT 1:200

EXISTING LEVELS

DESIGN LEVELS

DEPTH INVERT (m)

PIPE INVERT

PIPE GRADE

CHAINAGE


10.32

10.34

CP2-20A

SCALE: HORI 1:1000 VERT 1:200

225mm RCRRJ Ø

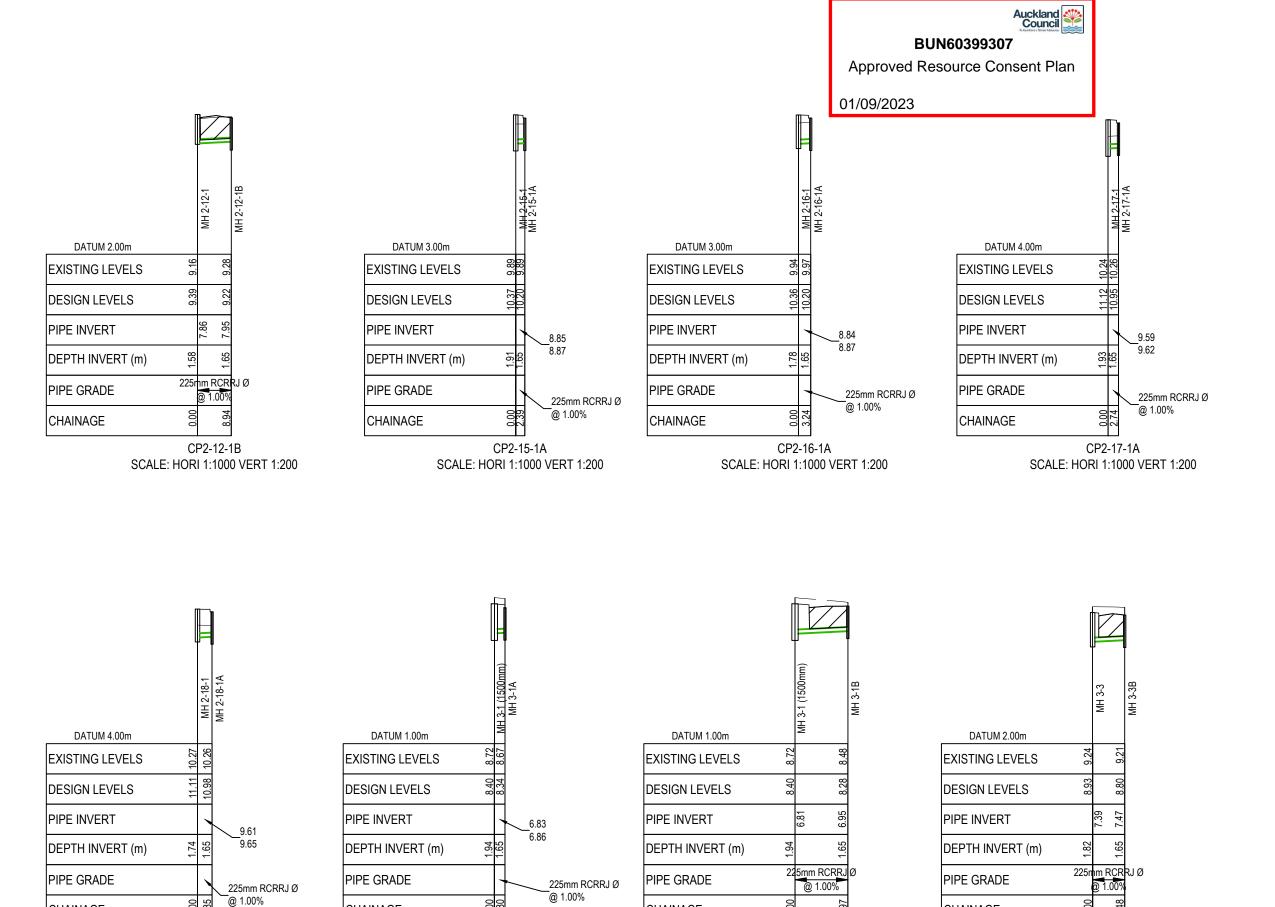

CHAINAGE

CP3-1B

SCALE: HORI 1:1000 VERT 1:200

CHAINAGE

CP3-3B

SCALE: HORI 1:1000 VERT 1:200

- All works to be in accordance with Auckland council standards.
 - Co-ordinates in terms of NZ Geodetic Datum Mt Eden 2000. Levels in terms of the Auckland Vertical Datum 1946.
 - . It is the contractors responsibility to locate all services that may be affected by his operations.
- Pipe bedding: 0 10% granular bedding,10 -20% weak concrete bedding.greater than 20% weak concrete bedding (7mpa plus anti scour blocks at 6m crs).
- Each connection shall be marked by a 50mmx50mm treated pine stake extending 600mm above ground level with the top painted This marker post shall be placed alongside a timber marker installed at the time of pipelaying and extending from the connection to 150mm below finished ground level. Connections shall be accurately indicated on "as built" plans.
- Approved hardfill is to be used in backfilling of all road crossings and vehicle crossings to council standards.
- Heavy duty manhole lids and frames to be used in trafficked areas.
- All Manholes are to be 1050mmØ unless shown
- Catchpit leads with 800mm or less cover shall be protected with concrete capping
- 0. All lines to be abandoned shall be sealed at each end. timing of all sealing to be coordinated with council staff.

- I	Legend	
		EX GROUND LEVEL PROP FINISHED LEVEL HARDFILL BACKFILL

G EPA RE		RFI		ML	02/2022		
F			A RFI		EPA RFI		02/2023
Е			ML	10/2022			
Rev	Desc	ription	on		Date		
		Ву	Date	te			
Surve	у	SURVEYWORX	12/202	12/2021			
Desig	n	JV	01/2022				
Drawn	1	MS	02/2022		•		
Check	ed	JP	02/20	22			

H S92 RFI

ML 04/2023



62, 78 & 80 PAPAKURA -**CLEVEDON ROAD,**

CLEVEDON, AUCKLAND FOR CLEVEDON **PROPERTIES LTD**

PROPOSED STORMWATER DRAINAGE **LONG SECTIONS**

	Project no.			
	Scale	1:1000 @ A3		
Cad file C400- DRAINAGE.DWG				
	Drawing no.	C437D	Rev	Н

RESOURCE CONSENT

CP2-18-1A


SCALE: HORI 1:1000 VERT 1:200

CHAINAGE

CHAINAGE

CP3-1A

SCALE: HORI 1:1000 VERT 1:200

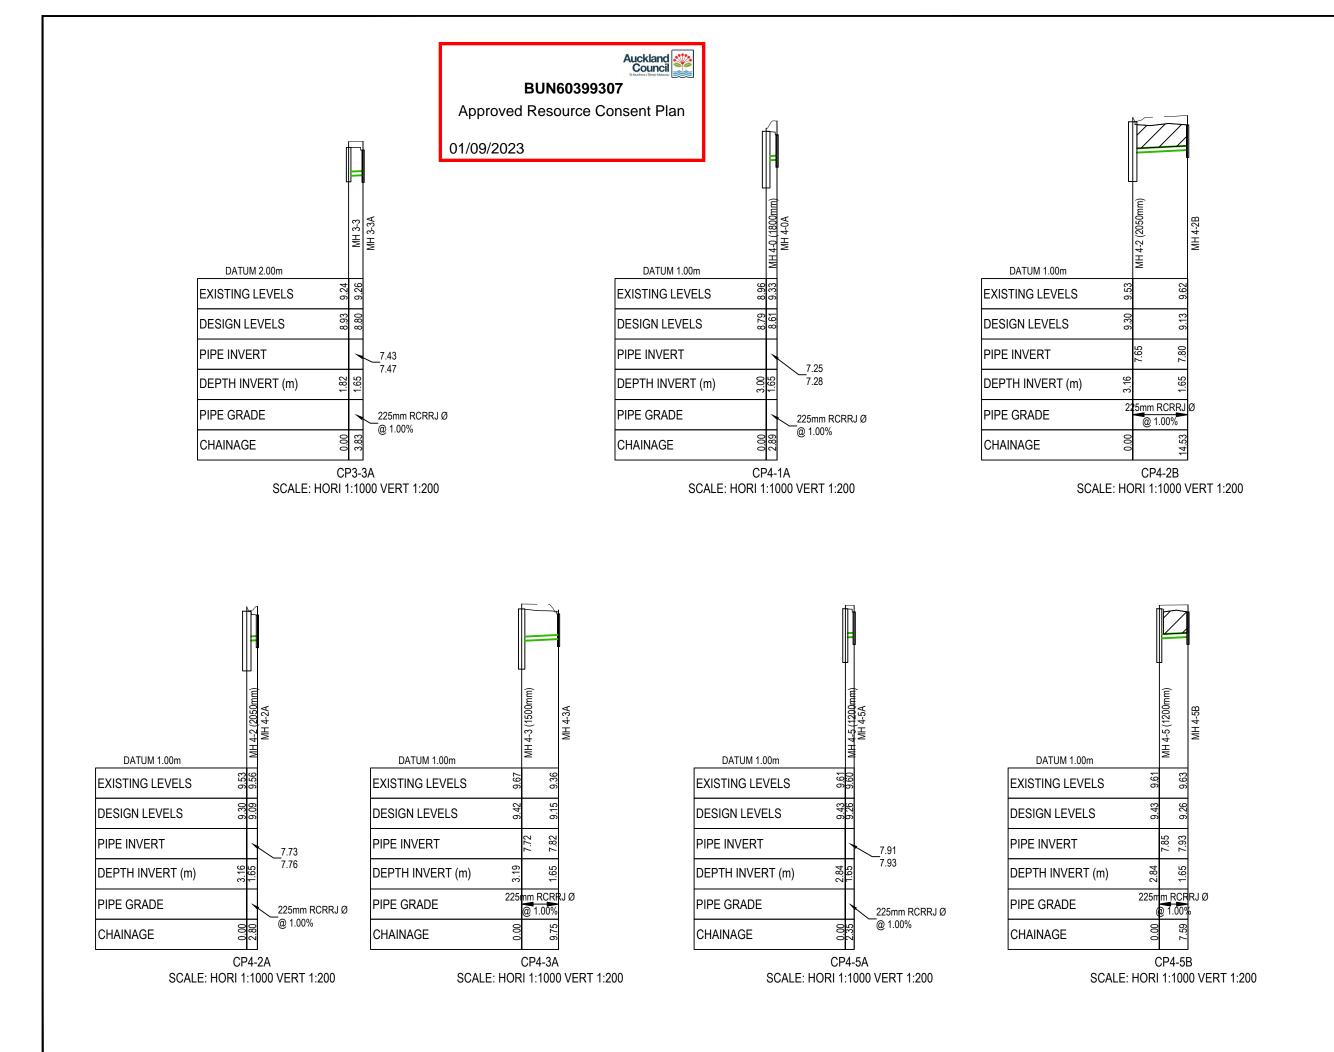

RESOURCE CONSENT

Notes

- All works to be in accordance with Auckland council standards.
- Co-ordinates in terms of NZ Geodetic Datum Mt Eden 2000. Levels in terms of the Auckland Vertical Datum 1946.
- 3. It is the contractors responsibility to locate all services that may be affected by his operations.
- Pipe bedding: 0 10% granular bedding,10 20% weak concrete bedding.greater than 20% weak concrete bedding (7mpa plus anti scour blocks at 6m crs).
- 5. Each connection shall be marked by a 50mmx50mm treated pine stake extending 600mm above ground level with the top painted This marker post shall be placed alongside a timber marker installed at the time of pipelaying and extending from the connection to 150mm below finished ground level. Connections shall be accurately indicated on "as built" plans.
- Approved hardfill is to be used in backfilling of all road crossings and vehicle crossings to council standards.
- Heavy duty manhole lids and frames to be used in trafficked areas.
- All Manholes are to be 1050mmØ unless showr otherwise.
- Catchpit leads with 800mm or less cover shall be protected with concrete capping.
- All lines to be abandoned shall be sealed at each end. timing of all sealing to be coordinated with council staff.

Legend

EX GROUND LEVEL

PROP FINISHED LEVEL

HARDFILL BACKFILL

П	G EPA RFI F EPA RFI		IVIL	04/2023	
G			ML	02/2022	
F			PA RFI		02/2023
Е	EPA	EPA RFI		ML	10/2022
Rev	Description			Ву	Date
		Ву	Date		·
Surve	у	SURVEYWORX	12/2021		
Design Drawn		JV	01/2022		
		MS	02/2022		
Check	ced	JP	02/2022		




62, 78 & 80 PAPAKURA -CLEVEDON ROAD, CLEVEDON, AUCKLAND FOR CLEVEDON

PROPERTIES LTD

PROPOSED
STORMWATER DRAINAGE
LONG SECTIONS

Project no.	194006			
Scale	1:1000 @ A3			
Cad file	C400- DRAINAGE.DWG			
Drawing no.	C437E	Rev	Н	

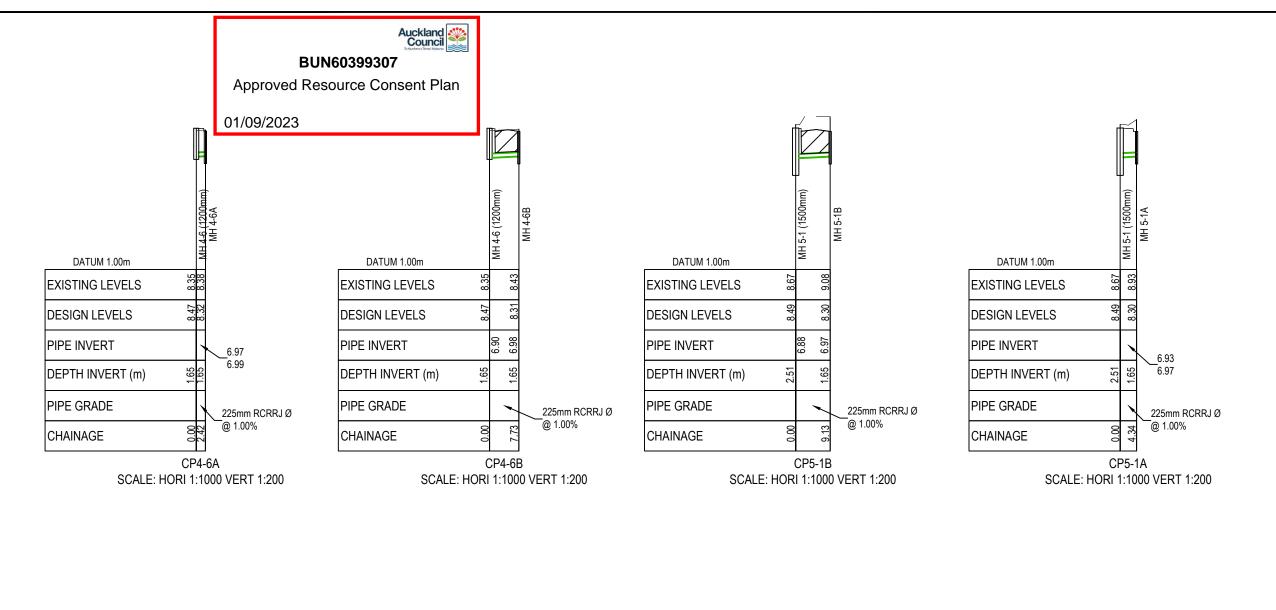


225mm RCRRJ Ø

@ 1.00%


CP5-3A

SCALE: HORI 1:1000 VERT 1:200

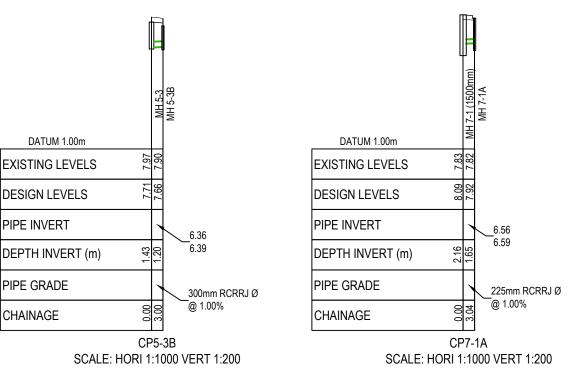

- All works to be in accordance with Auckland council standards.
- Co-ordinates in terms of NZ Geodetic Datum Mt Eden 2000. Levels in terms of the Auckland
- Vertical Datum 1946. . It is the contractors responsibility to locate all services that may be affected by his operations.
- Pipe bedding: 0 10% granular bedding,10 -20% weak concrete bedding.greater than 20% weak concrete bedding (7mpa plus anti scour blocks at 6m crs).
- Each connection shall be marked by a 50mmx50mm treated pine stake extending 600mm above ground level with the top painted This marker post shall be placed alongside a timber marker installed at the time of pipelaying and extending from the connection to 150mm below finished ground level. Connections shall be accurately indicated on "as built" plans.
- Approved hardfill is to be used in backfilling of all road crossings and vehicle crossings to council standards.
- Heavy duty manhole lids and frames to be used in trafficked areas.
- All Manholes are to be 1050mmØ unless shown
- Catchpit leads with 800mm or less cover shall be protected with concrete capping.
- 0. All lines to be abandoned shall be sealed at each end. timing of all sealing to be coordinated with council staff.

FX GROUND I EVEL PROP FINISHED LEVEL HARDFILL BACKFILL

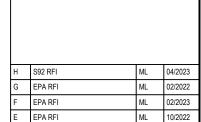

	Rev	Desc	cription		Ву	Date
	Survey Design		Ву	Date		
			SURVEYWORX	12/2021		
			JV	01/2022		
	Drawr	1	MS	02/202	22	
	Chool	rod.	ID	02/2022		



62, 78 & 80 PAPAKURA -**CLEVEDON ROAD, CLEVEDON, AUCKLAND** FOR CLEVEDON **PROPERTIES LTD**

PROPOSED STORMWATER DRAINAGE LONG SECTIONS

Project no.	194006		
Scale	1:1000 @ A3		
Cad file	C400- DRAINAGE.DWG		
Drawing no.	C437F	Rev	Н

RESOURCE CONSENT

DATUM 1.00m

EXISTING LEVELS

DESIGN LEVELS

DEPTH INVERT (m)

225mm RCRRJ Ø

@ 1.00%

CP5-2A

SCALE: HORI 1:1000 VERT 1:200

PIPE INVERT

PIPE GRADE

CHAINAGE

DATUM 1.00m

EXISTING LEVELS


DESIGN LEVELS


DEPTH INVERT (m)

PIPE INVERT

PIPE GRADE

CHAINAGE

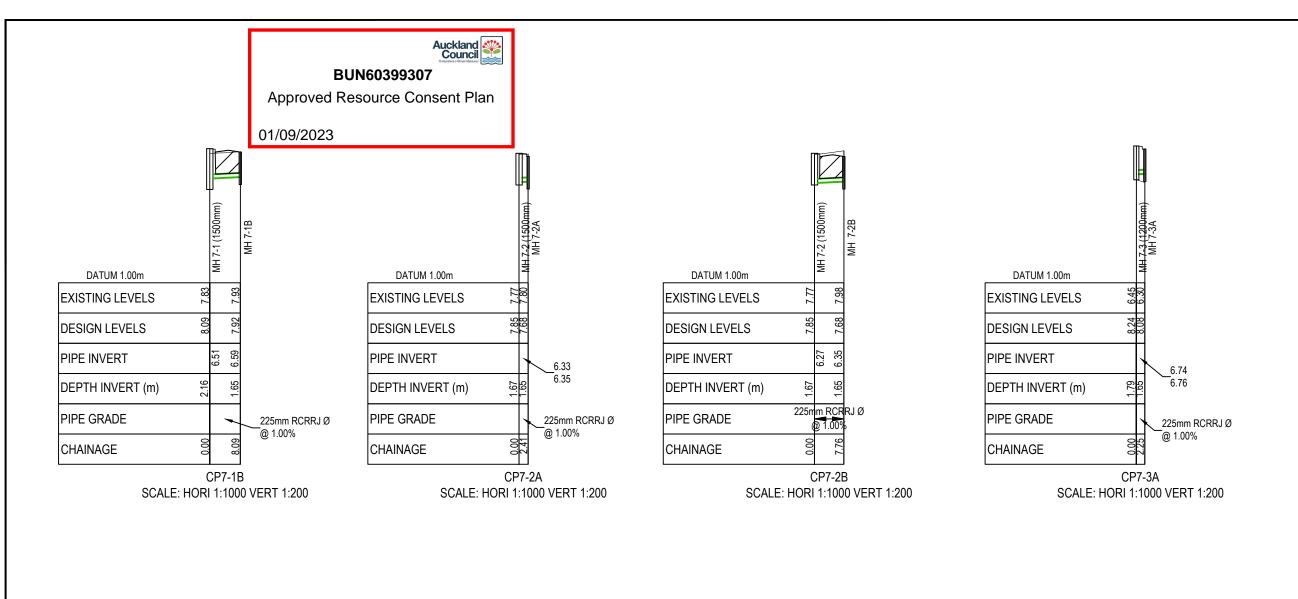

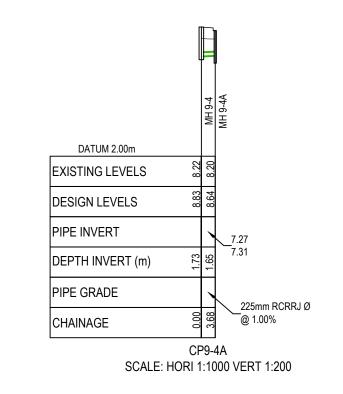

Note

- All works to be in accordance with Auckland council standards.
- Co-ordinates in terms of NZ Geodetic Datum Mt Eden 2000. Levels in terms of the Auckland Vertical Datum 1946.
- It is the contractors responsibility to locate all services that may be affected by his operations.
- Pipe bedding: 0 10% granular bedding,10 20% weak concrete bedding.greater than 20% weak concrete bedding (7mpa plus anti scour blocks at 6m crs).
- 5. Each connection shall be marked by a 50mmx50mm treated pine stake extending 600mm above ground level with the top painted This marker post shall be placed alongside a timber marker installed at the time of pipelaying and extending from the connection to 150mm below finished ground level. Connections shall be accurately indicated on "as built" plans.
- Approved hardfill is to be used in backfilling of all road crossings and vehicle crossings to council standards.
- Heavy duty manhole lids and frames to be used in trafficked areas.
- All Manholes are to be 1050mmØ unless showr otherwise.
- Catchpit leads with 800mm or less cover shall be protected with concrete capping.
- All lines to be abandoned shall be sealed at each end. timing of all sealing to be coordinated with council staff.

Legend EX GROUND LEVEL PROP FINISHED LEVEL HARDFILL BACKFILL

				l	
G	G EPA RFI		ML	02/2022	
F	F EPA RFI			ML	02/2023
Е	EPA RFI			ML	10/2022
Rev	Desc	ription		Ву	Date
		Ву	Date		
Surve	у	SURVEYWORX	12/2021		
Desig	n	JV	01/2022		
Drawn		MS	02/2022		
Chack	rΔd	ID	02/20	02/2022	

ML 04/2023


H S92 RFI




62, 78 & 80 PAPAKURA - CLEVEDON ROAD, CLEVEDON, AUCKLAND FOR CLEVEDON PROPERTIES LTD


PROPOSED STORMWATER DRAINAGE LONG SECTIONS

Project no.	194006			
Scale	1:1000 @ A3			
Cad file	C400- DRAINAGE.DWG			
Drawing no.	C437G	Rev	Н	

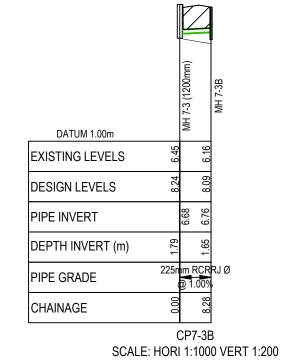


RESOURCE CONSENT

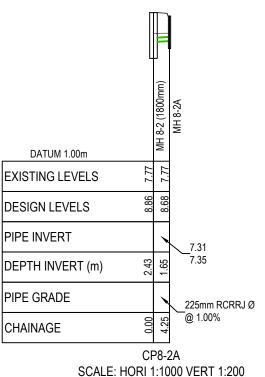

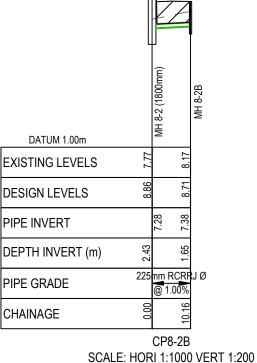

E: HORI 1:1000 VERT 1:200 SCALE: H

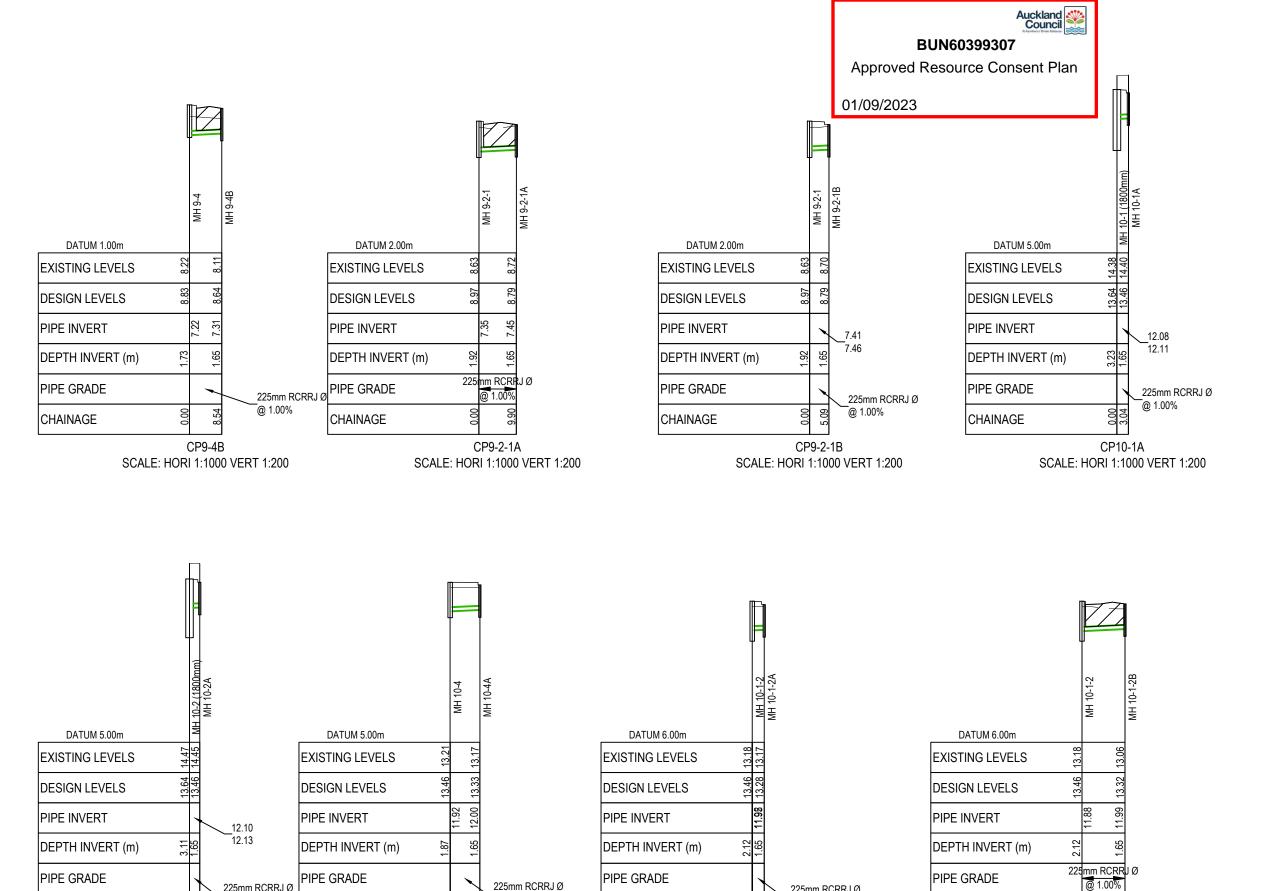

CHAINAGE

225mm RCRRJ Ø

CHAINAGE

CP10-1-2B

SCALE: HORI 1:1000 VERT 1:200

@ 1.00%

CP10-1-2A

SCALE: HORI 1:1000 VERT 1:200

225mm RCRRJ Ø

@ 1.00%

CP10-4A

SCALE: HORI 1:1000 VERT 1:200

- All works to be in accordance with Auckland council standards.
- Co-ordinates in terms of NZ Geodetic Datum Mt Eden 2000. Levels in terms of the Auckland Vertical Datum 1946.
- . It is the contractors responsibility to locate all services that may be affected by his operations.
- Pipe bedding: 0 10% granular bedding,10 -20% weak concrete bedding.greater than 20% weak concrete bedding (7mpa plus anti scour blocks at 6m crs).
- Each connection shall be marked by a 50mmx50mm treated pine stake extending 600mm above ground level with the top painted This marker post shall be placed alongside a timber marker installed at the time of pipelaying and extending from the connection to 150mm below finished ground level. Connections shall be accurately indicated on "as built" plans.
- Approved hardfill is to be used in backfilling of all road crossings and vehicle crossings to council standards.
- Heavy duty manhole lids and frames to be used in trafficked areas.
- All Manholes are to be 1050mmØ unless shown
- Catchpit leads with 800mm or less cover shall be protected with concrete capping.
- 0. All lines to be abandoned shall be sealed at each end. timing of all sealing to be coordinated with council staff.

FX GROUND I EVEL PROP FINISHED LEVEL HARDFILL BACKFILL

Н	S92 RFI			ML	04/2023
G	EPA	EPA RFI		ML	02/2022
F	EPA			PA RFI	
Е	EPA RFI			ML	10/2022
Rev	Desc	scription		Ву	Date
		Ву	Date	Date	
Surve	у	SURVEYWORX	12/20	12/2021	
Design Drawn		JV	01/20	01/2022	
		MS	02/20	02/2022	
Chec	ked	JP	02/20	02/2022	



62, 78 & 80 PAPAKURA -**CLEVEDON ROAD,**

CLEVEDON, AUCKLAND FOR CLEVEDON **PROPERTIES LTD**

PROPOSED STORMWATER DRAINAGE **LONG SECTIONS**

	Project no. 194006			
Project no. 194006 Scale 1:1000 @ A3 Cad file C400- DRAINAGE.DWG				
	Drawing no.	C437H	Rev	Н

RESOURCE CONSENT


CHAINAGE

225mm RCRRJ Ø

CHAINAGE

CP10-2A

SCALE: HORI 1:1000 VERT 1:200

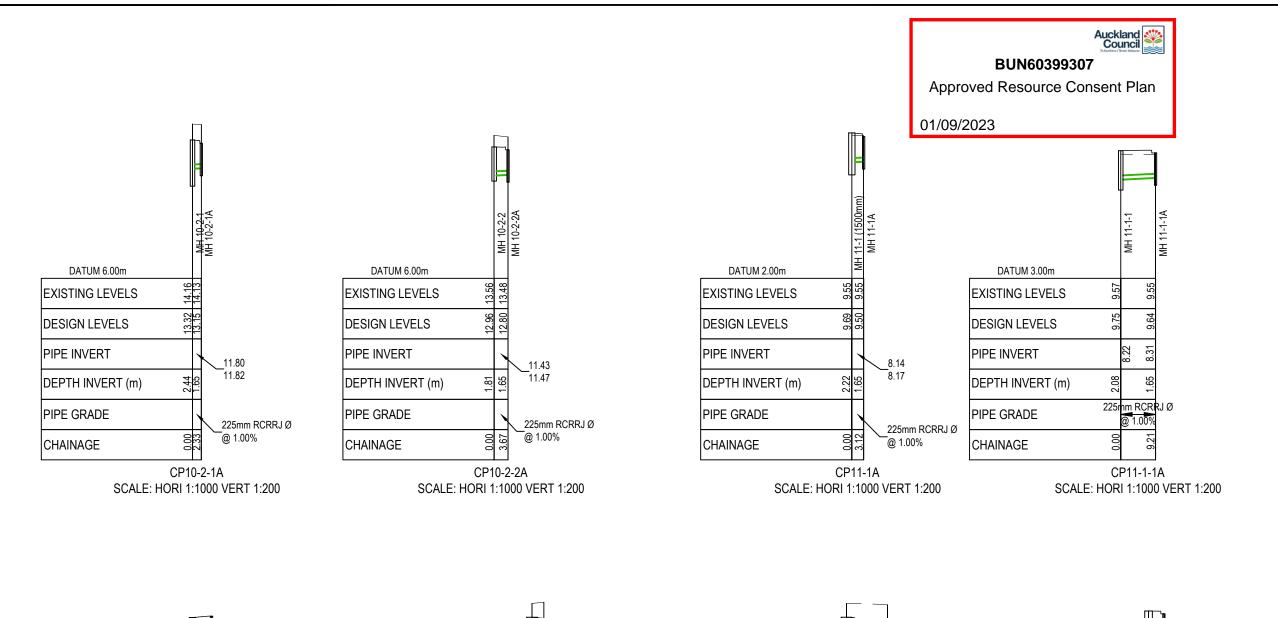

12.70 | MH 12-2 (2550) MH 12-2 A

CP12-2A

SCALE: HORI 1:1000 VERT 1:200

225mm RCRRJ Ø

@ 1.00%

DATUM 4.00m

EXISTING LEVELS


DESIGN LEVELS

DEPTH INVERT (m)

PIPE INVERT

PIPE GRADE

CHAINAGE

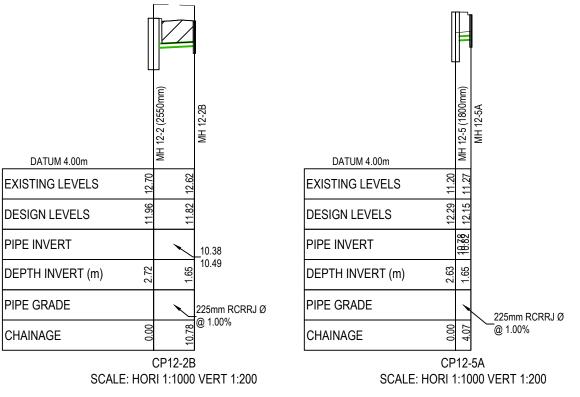

- All works to be in accordance with Auckland council standards.
 - Co-ordinates in terms of NZ Geodetic Datum Mt Eden 2000. Levels in terms of the Auckland Vertical Datum 1946.
 - It is the contractors responsibility to locate all services that may be affected by his operations.
- Pipe bedding: 0 10% granular bedding,10 -20% weak concrete bedding.greater than 20% weak concrete bedding (7mpa plus anti scour blocks at 6m crs).
- Each connection shall be marked by a 50mmx50mm treated pine stake extending 600mm above ground level with the top painted This marker post shall be placed alongside a timber marker installed at the time of pipelaying and extending from the connection to 150mm below finished ground level. Connections shall be accurately indicated on "as built" plans.
- Approved hardfill is to be used in backfilling of all road crossings and vehicle crossings to council
- Heavy duty manhole lids and frames to be used in trafficked areas.
- All Manholes are to be 1050mmØ unless shown
- Catchpit leads with 800mm or less cover shall be protected with concrete capping
- 0. All lines to be abandoned shall be sealed at each end. timing of all sealing to be coordinated with council staff.



	п	592 RFI			IVIL	04/2023
	G	EPA RFI			ML	02/2022
	F	EPA RFI			ML	02/2023
	Е	EPA	RFI		ML	10/2022
	Rev Desc		cription		Ву	Date
			Ву	Date		
	Surve	y	SURVEYWORX	12/202	12/2021	
	Design Drawn		JV	01/2022		
			MS	02/2022		
	Check	ed	JP	02/20	22	·



62, 78 & 80 PAPAKURA -**CLEVEDON ROAD, CLEVEDON, AUCKLAND** FOR CLEVEDON **PROPERTIES LTD**

PROPOSED STORMWATER DRAINAGE LONG SECTIONS

194006 Project no. 1:1000 @ A3 Cad file C400- DRAINAGE.DWG Rev H

RESOURCE CONSENT

DATUM 2.00m

EXISTING LEVELS

DESIGN LEVELS

DEPTH INVERT (m)

PIPE INVERT

PIPE GRADE

CHAINAGE

9.12

10.01


8.62 8.67


1.65


CP11-3A


SCALE: HORI 1:1000 VERT 1:200

225mm RCRRJ Ø

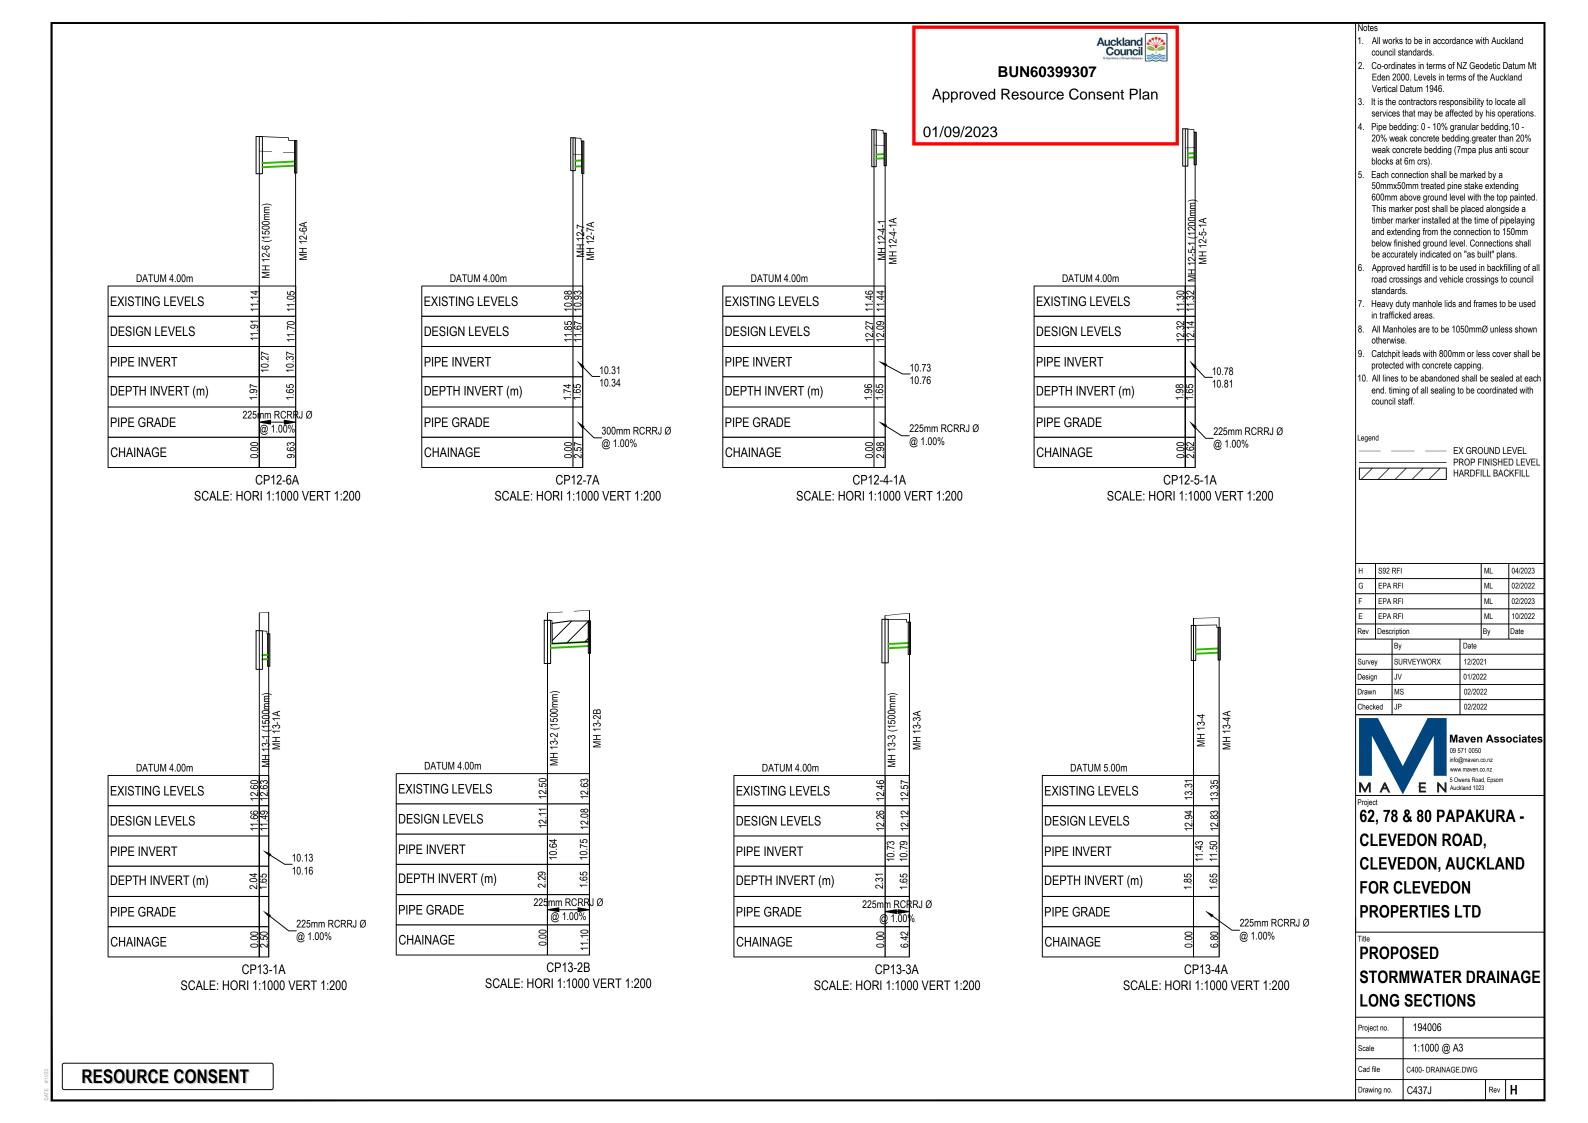

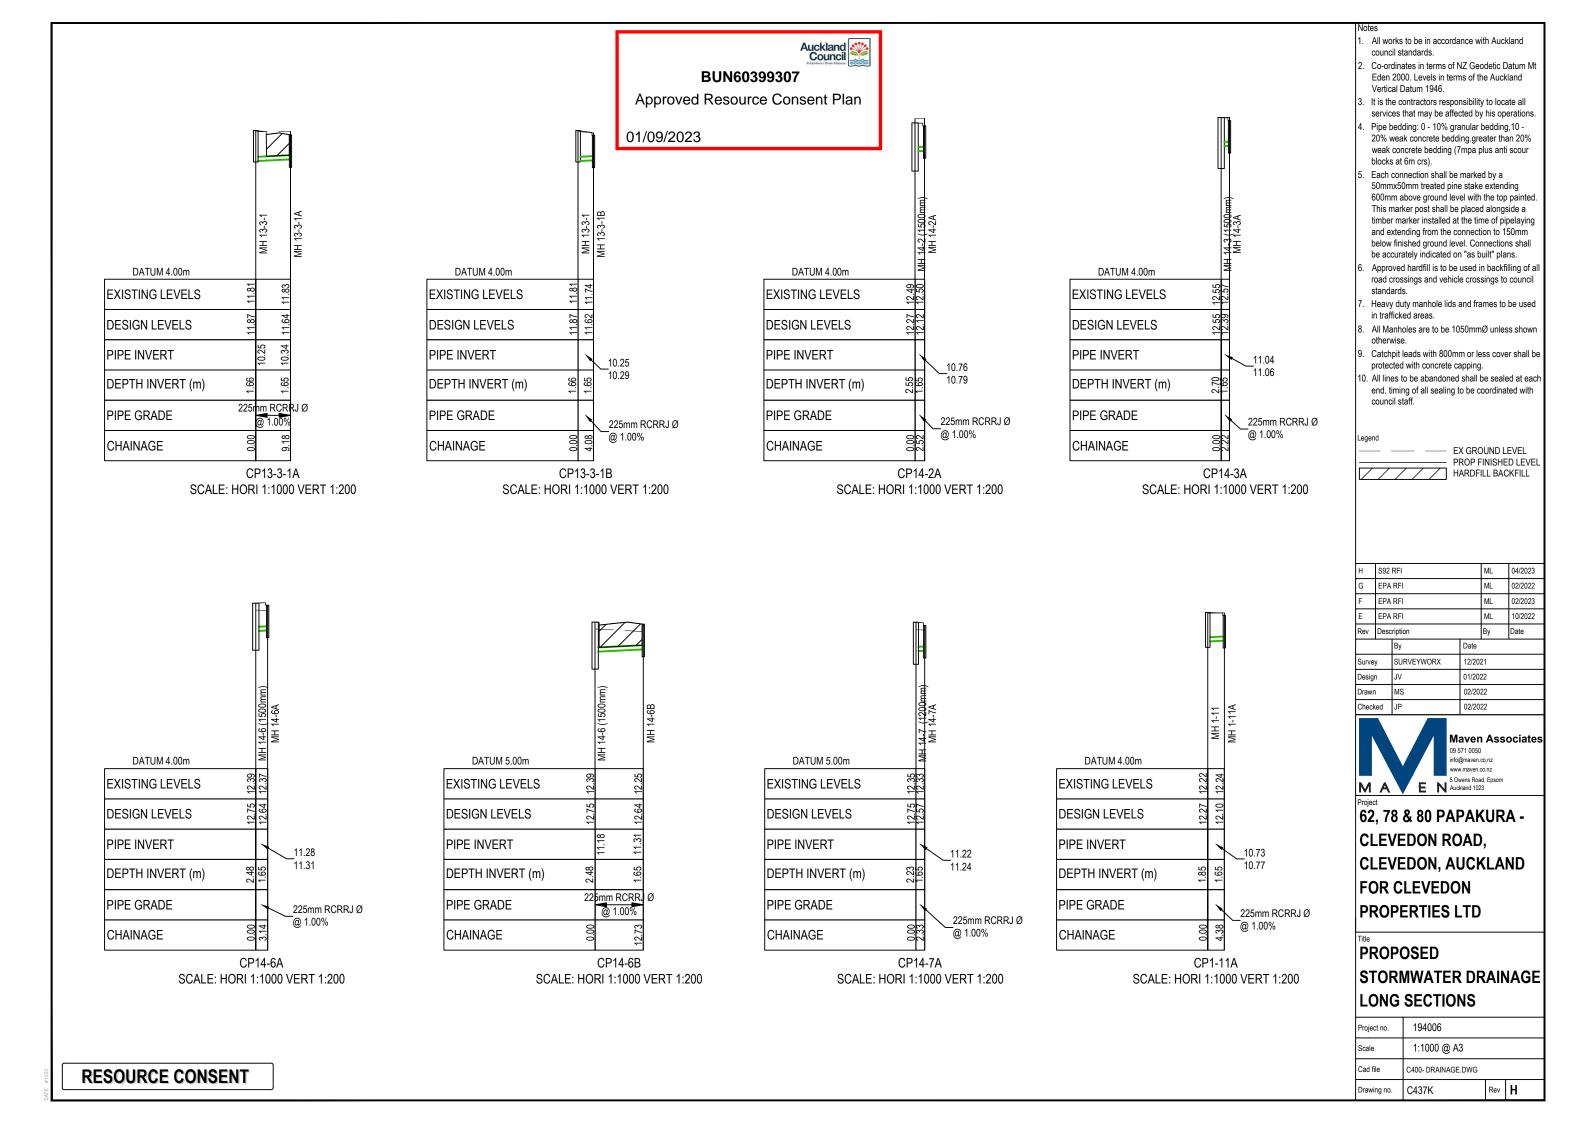

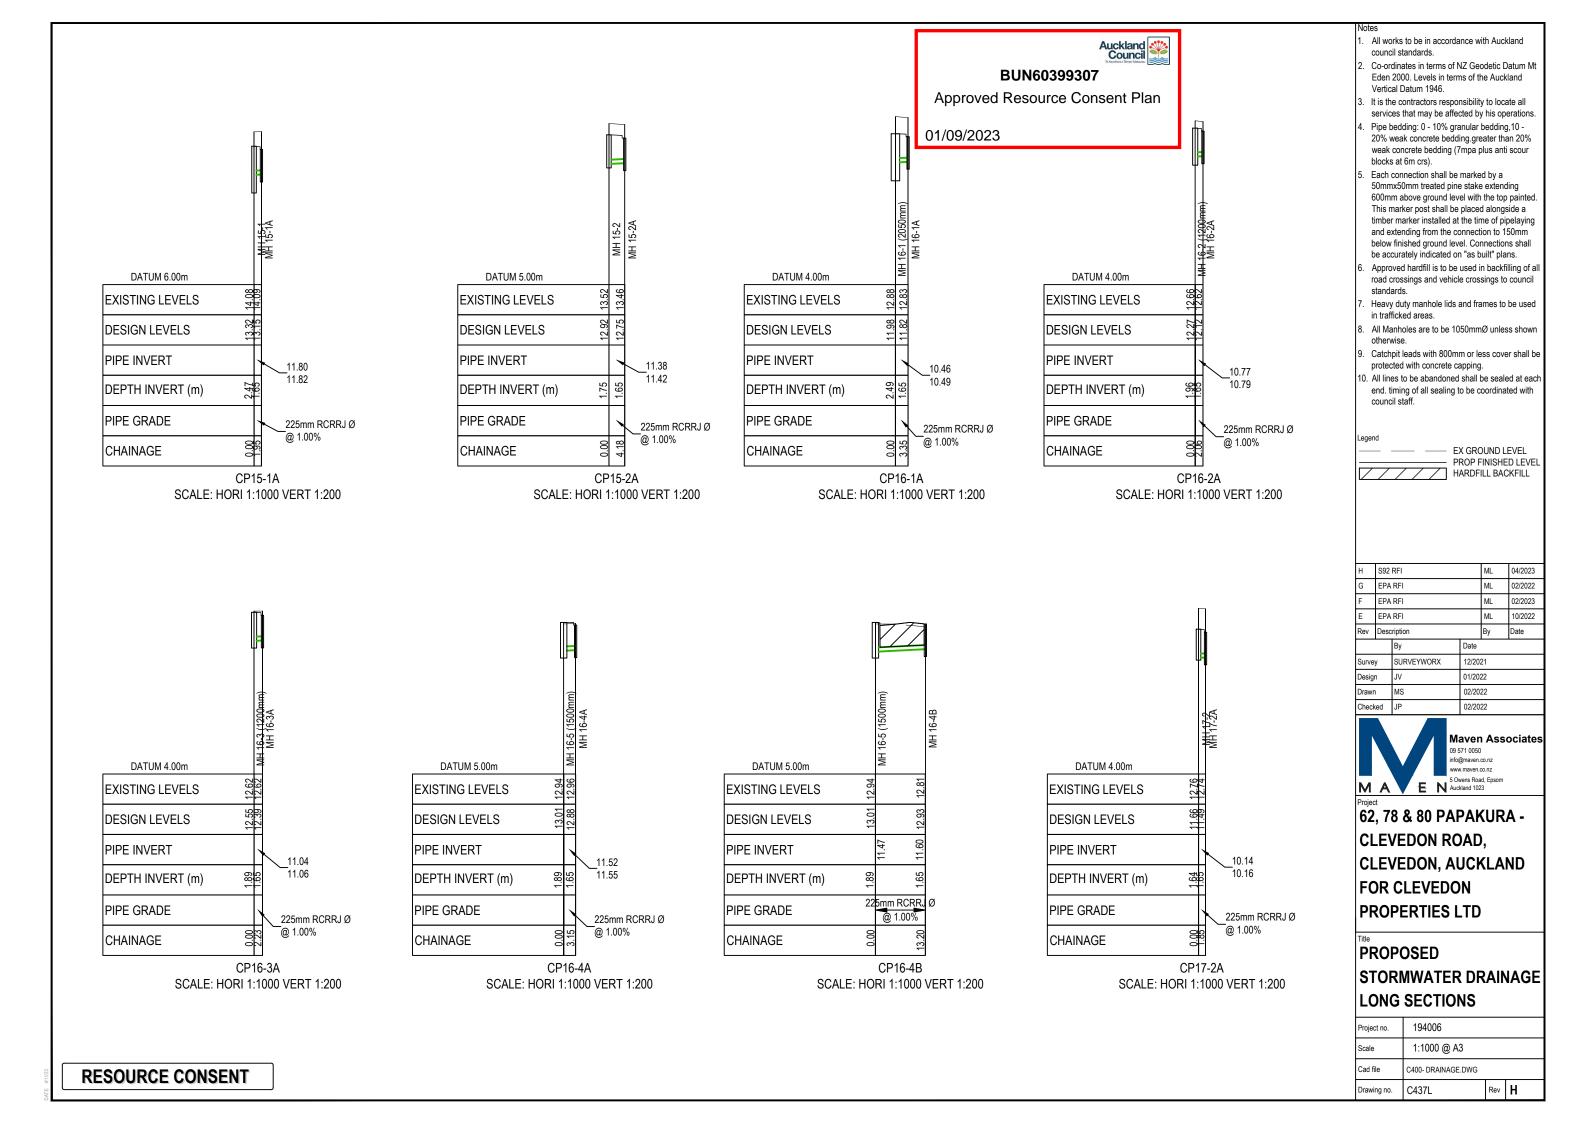

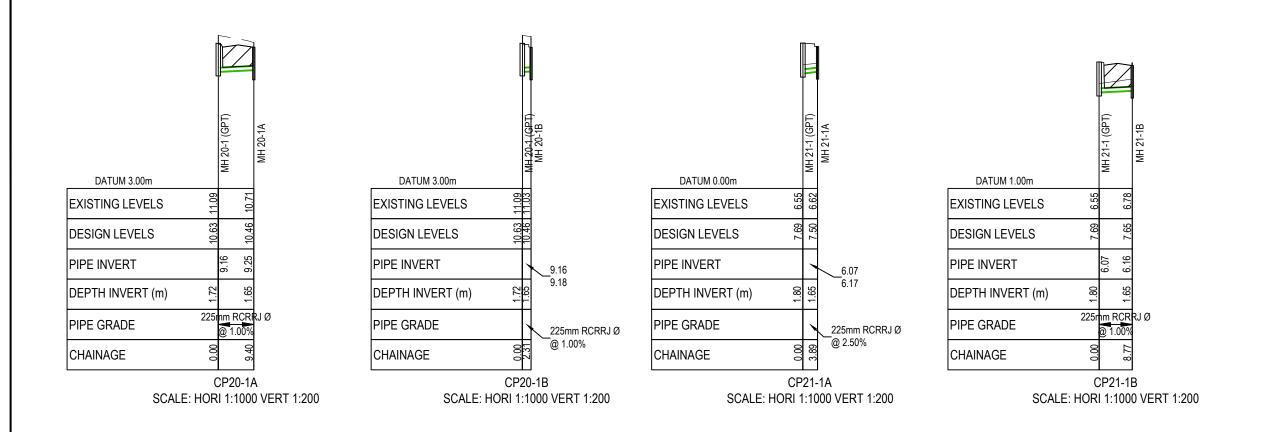

- All works to be in accordance with Auckland council standards.
- Co-ordinates in terms of NZ Geodetic Datum Mt Eden 2000. Levels in terms of the Auckland Vertical Datum 1946.
- . It is the contractors responsibility to locate all services that may be affected by his operations.
- Pipe bedding: 0 10% granular bedding,10 -20% weak concrete bedding.greater than 20% weak concrete bedding (7mpa plus anti scour blocks at 6m crs).
- Each connection shall be marked by a 50mmx50mm treated pine stake extending 600mm above ground level with the top painted This marker post shall be placed alongside a timber marker installed at the time of pipelaying and extending from the connection to 150mm below finished ground level. Connections shall be accurately indicated on "as built" plans.
- 6. Approved hardfill is to be used in backfilling of all road crossings and vehicle crossings to council standards.
- Heavy duty manhole lids and frames to be used in trafficked areas.
- . All Manholes are to be 1050mmØ unless shown
- Catchpit leads with 800mm or less cover shall be protected with concrete capping.
- 10. All lines to be abandoned shall be sealed at each end. timing of all sealing to be coordinated with council staff.

EX GROUND LEVEL PROP FINISHED LEVEL
HARDFILL BACKFILL

l H	G EPA RFI F EPA RFI E EPA RFI		IVIL	04/2023	
G			ML	02/2022	
F			ML	02/2023	
Е				ML	10/2022
Rev	Desc	ription	n		Date
		Ву	Date	ate	
Surve	у	SURVEYWORX	12/20	12/2021	
Desig	n	JV	01/20	01/2022	
Drawr	1	MS	02/20	02/2022	
Check	red	JP	02/20	22	



62, 78 & 80 PAPAKURA -**CLEVEDON ROAD,** CLEVEDON, AUCKLAND **FOR CLEVEDON PROPERTIES LTD**


PROPOSED STORMWATER DRAINAGE LONG SECTIONS


Project no.	194006		
Scale	1:1000 @ A3		
Cad file	C400- DRAINAGE.DWG		
Orawing no.	C437M	Rev	Н


Auckland Council BUN60399307

Approved Resource Consent Plan

01/09/2023

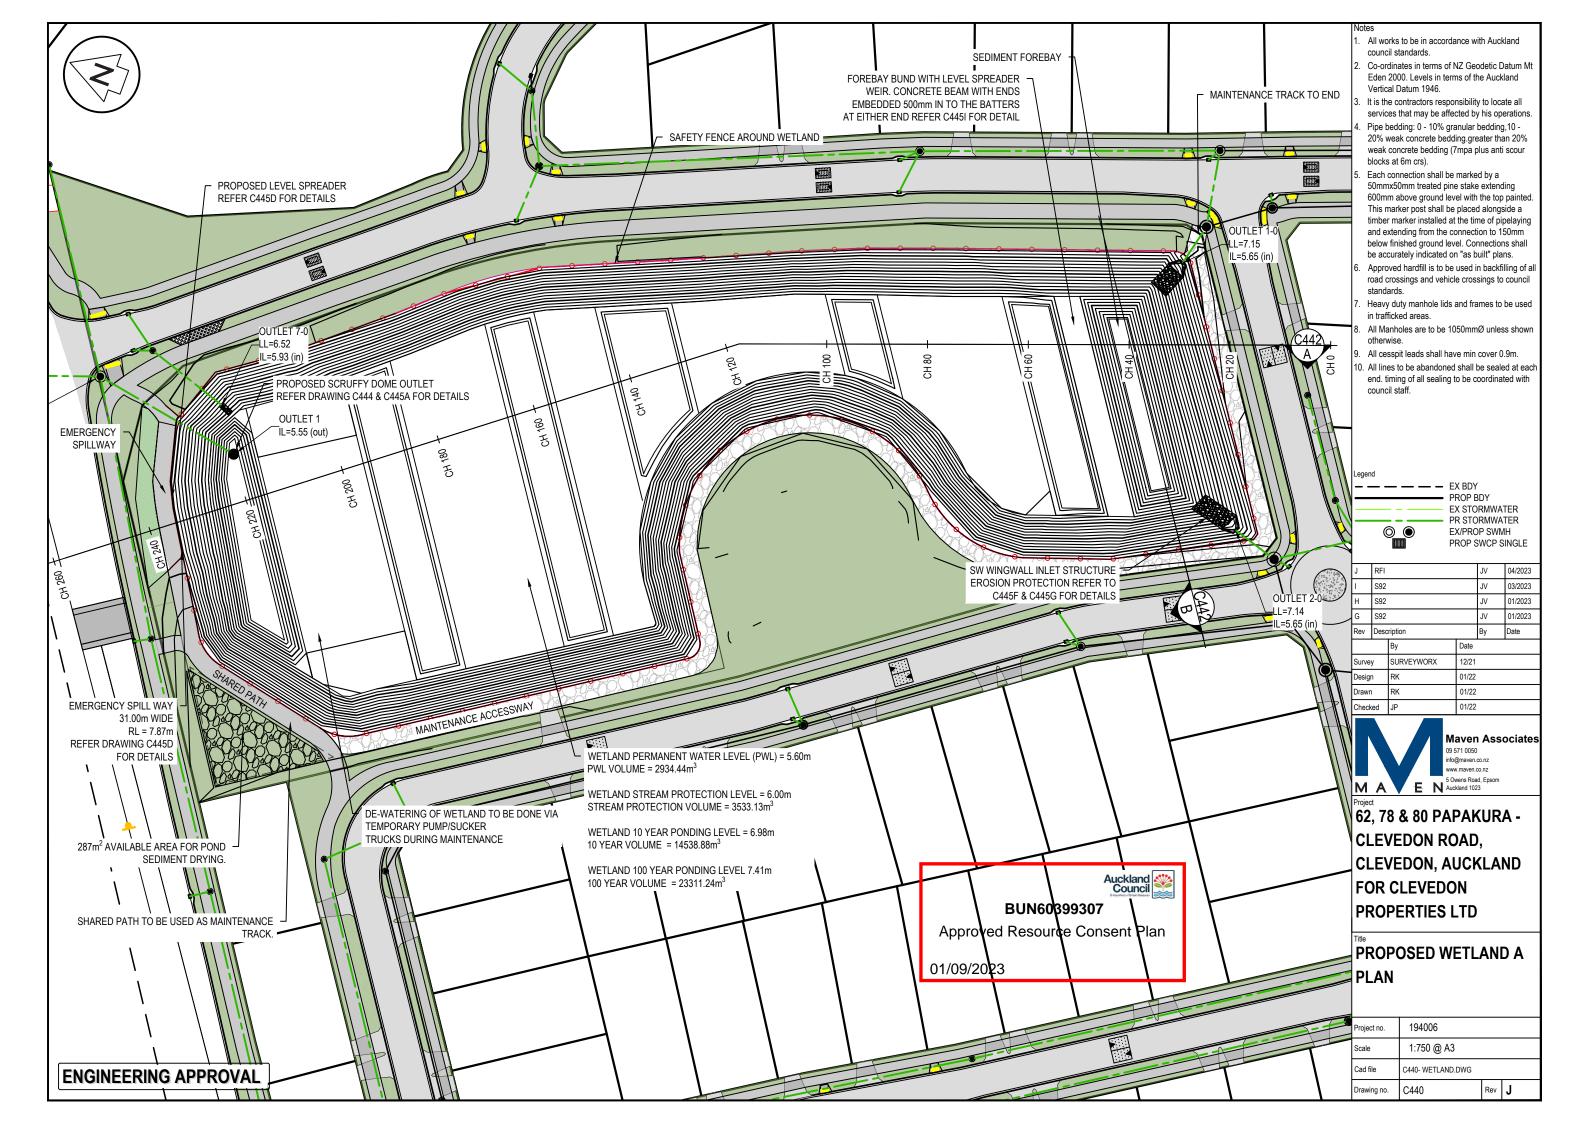


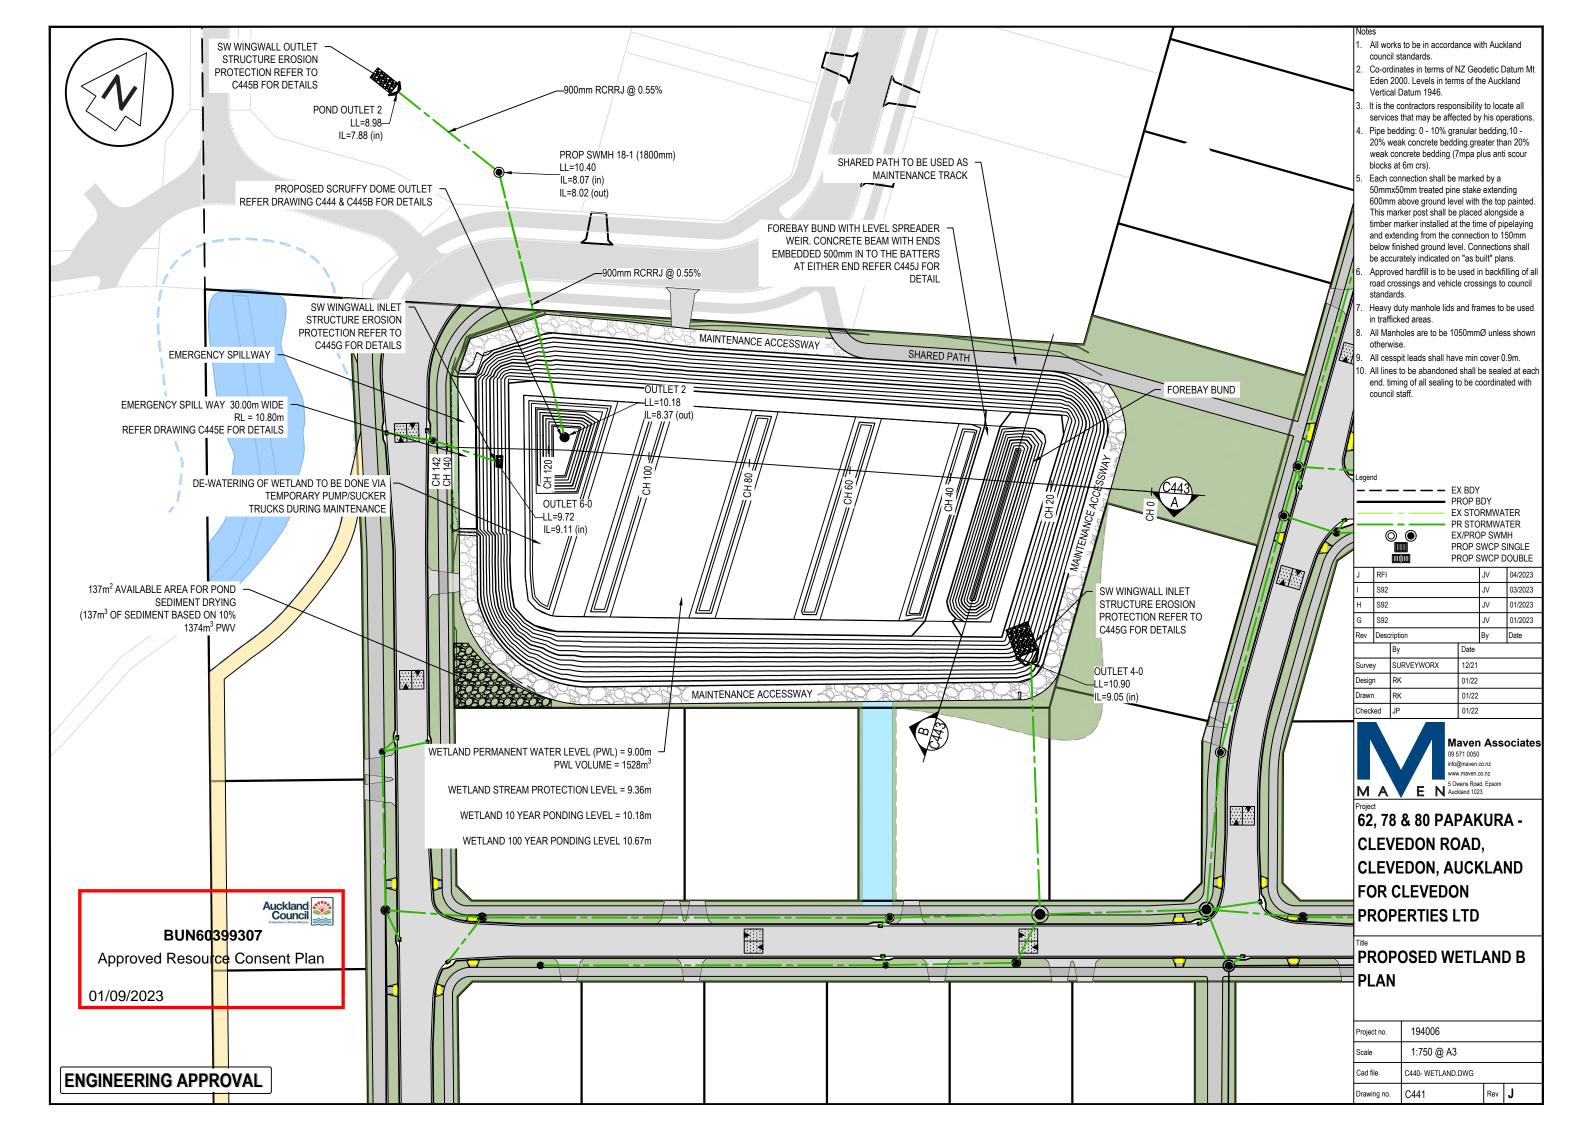

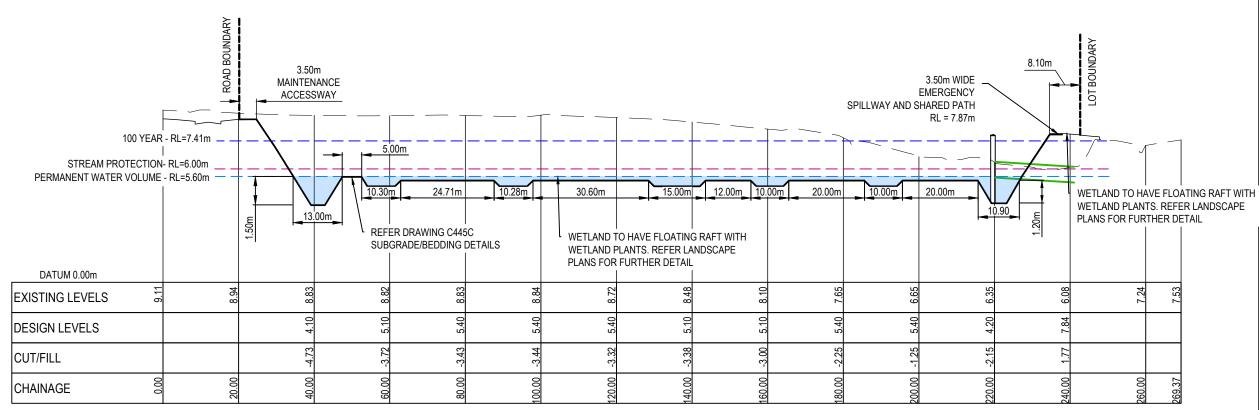

PROPOSED WETLAND A LONGSECTION A

SCALE 1:1000 HORZ 1:200 VERT

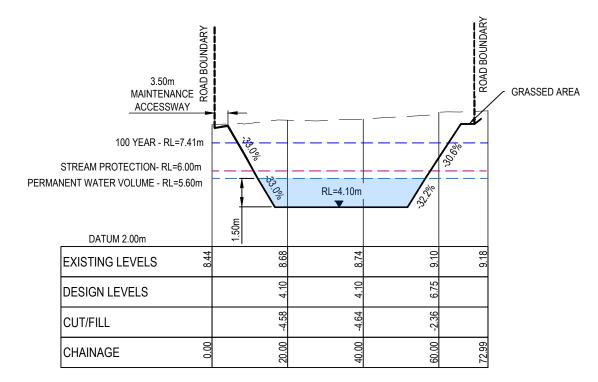

PROPOSED WETLAND A CROSS SECTION B


SCALE 1:1000 HORZ 1:200 VERT

Auckland Council
BUN60399307

Approved Resource Consent Plan
01/09/2023

Not

- All works to be in accordance with Auckland council standards.
- Co-ordinates in terms of NZ Geodetic Datum Mt Eden 2000. Levels in terms of the Auckland Vertical Datum 1946.
- It is the contractors responsibility to locate all services that may be affected by his operations.
- Pipe bedding: 0 10% granular bedding,10 -20% weak concrete bedding.greater than 20% weak concrete bedding (7mpa plus anti scour blocks at 6m crs).
- . Each connection shall be marked by a 50mmx50mm treated pine stake extending 600mm above ground level with the top painted. This marker post shall be placed alongside a timber marker installed at the time of pipelaying and extending from the connection to 150mm below finished ground level. Connections shall be accurately indicated on "as built" plans. Approved hardfill is to be used in backfilling of all road crossings and vehicle crossings to council standards.
- 7. Heavy duty manhole lids and frames to be used in trafficked areas.
- All Manholes are to be 1050mmØ unless showr otherwise.
- 9. All cesspit leads shall have min cover 0.9m.
- All lines to be abandoned shall be sealed at each end. timing of all sealing to be coordinated with council staff.

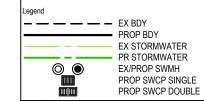

J	RH			JV	04/2023	
I S92				JV	03/2023	
Н	S92			JV	01/2023	
G	G S92		JV	01/2023		
Rev	Desc	ription	By Dat		Date	
		Ву	Date	е		
Surve	у	SURVEYWORX	12/21	12/21		
Desig	n	RK	01/22	01/22		
Drawr	1	RK	01/22		·	
Check	red	JP	01/22	01/22		




62, 78 & 80 PAPAKURA -CLEVEDON ROAD, CLEVEDON, AUCKLAND FOR CLEVEDON

Title

PROPOSED WETLAND A LONGSECTION AND CROSS SECTION


PROPERTIES LTD

	Project no.	194006		
	Scale	AS SHOWN		
	Cad file	C440- WETLAND.DWG		
	Drawing no.	C442	Rev	J

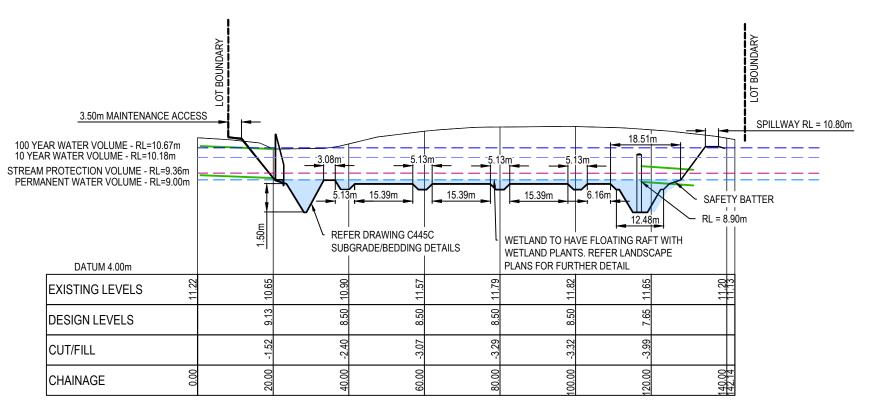

PROPOSED WETLAND B LONGSECTION A

SCALE 1:1000 HORZ 1:200 VERT

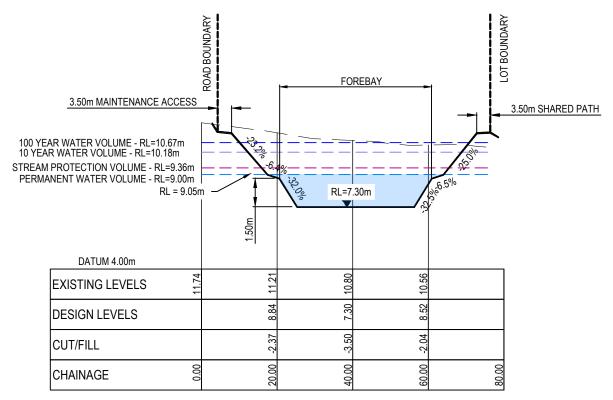

PROPOSED WETLAND B CROSS SECITON B

SCALE 1:1000 HORZ 1:200 VERT

Auckland Council


BUN60399307

Approved Resource Consent Plan

01/09/2023

Notes

- All works to be in accordance with Auckland council standards.
- Co-ordinates in terms of NZ Geodetic Datum Mt Eden 2000. Levels in terms of the Auckland Vertical Datum 1946.
- It is the contractors responsibility to locate all services that may be affected by his operations.
- Pipe bedding: 0 10% granular bedding,10 20% weak concrete bedding.greater than 20% weak concrete bedding (7mpa plus anti scour blocks at 6m crs).
- 5. Each connection shall be marked by a 50mmx50mm treated pine stake extending 600mm above ground level with the top painted. This marker post shall be placed alongside a timber marker installed at the time of pipelaying and extending from the connection to 150mm below finished ground level. Connections shall be accurately indicated on "as built" plans.
- Approved hardfill is to be used in backfilling of all road crossings and vehicle crossings to council standards.
- 7. Heavy duty manhole lids and frames to be used in trafficked areas.
- All Manholes are to be 1050mmØ unless shown otherwise
- 9. All cesspit leads shall have min cover 0.9m.
- All lines to be abandoned shall be sealed at each end. timing of all sealing to be coordinated with council staff.

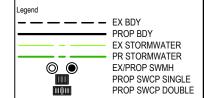

	J	S92			JV	04/2023	
	Ι				JV	03/2023	
	Н	S92			JV	01/2023	
	G	S92			JV	01/2023	
	Rev Desc		ription		Ву	Date	
			Ву	Date			
	Surve	y	SURVEYWORX	12/21	12/21		
	Design Drawn		RK	01/22 01/22			
			RK				
	Check	æd	JP	01/22			




62, 78 & 80 PAPAKURA CLEVEDON ROAD,
CLEVEDON, AUCKLAND
FOR CLEVEDON
PROPERTIES LTD

Title

PROPOSED WETLAND B LONGSECTION AND CROSS SECTION

Project no.	194006			
Scale	AS SHOWN			
Cad file	C440- WETLAND.DWG			
Drawing no.	C443	Rev	J	

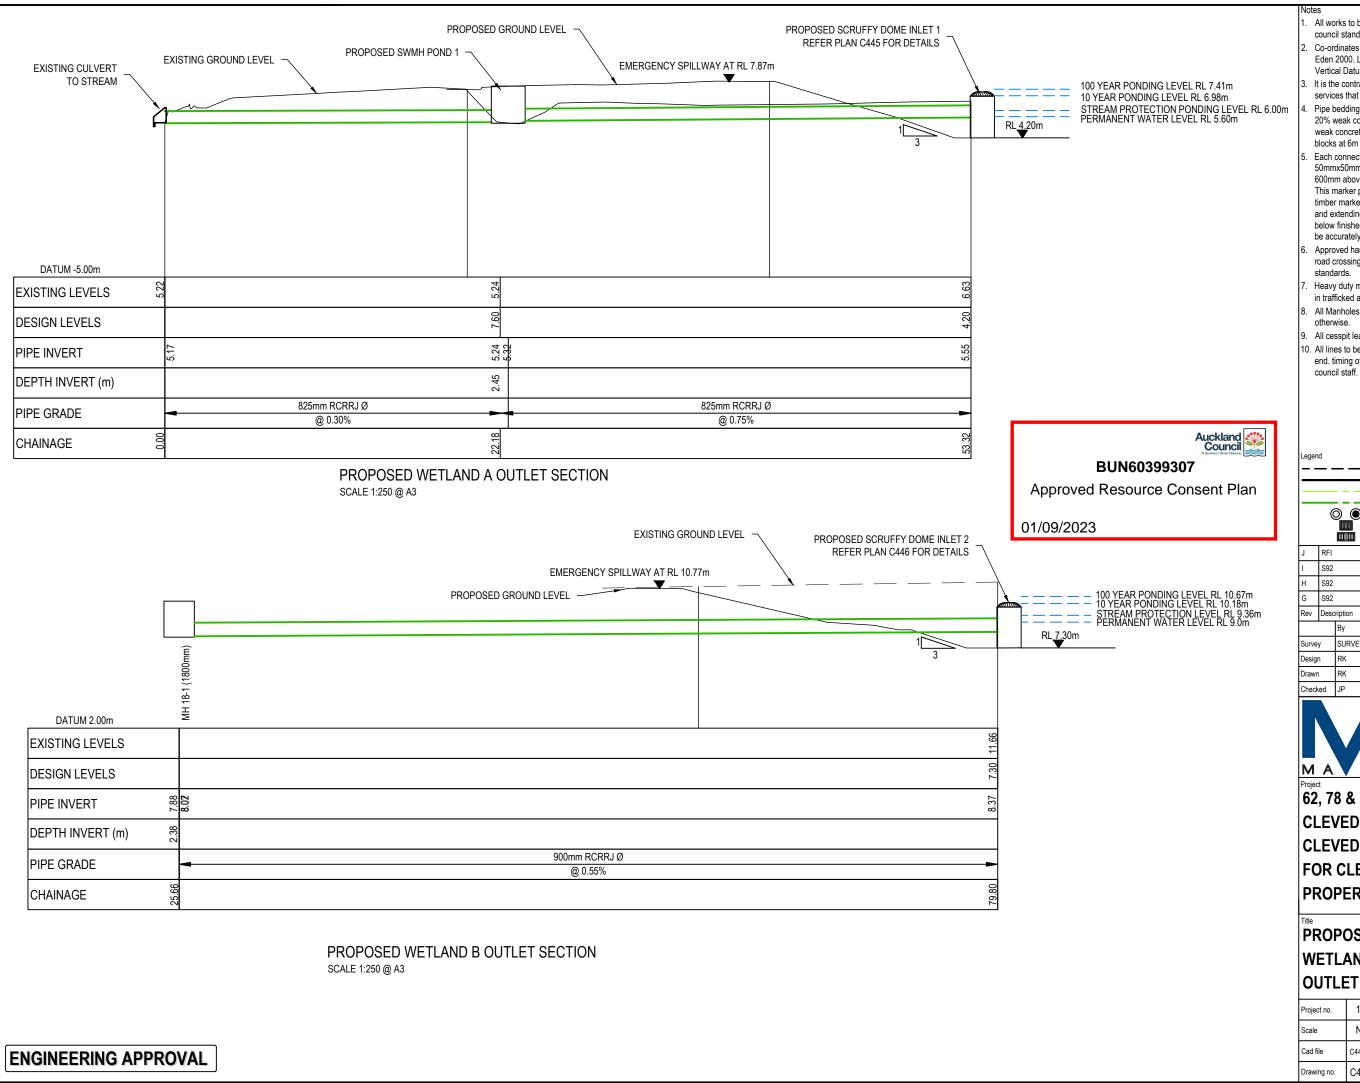

- All works to be in accordance with Auckland council standards.
 - Co-ordinates in terms of NZ Geodetic Datum Mt Eden 2000. Levels in terms of the Auckland Vertical Datum 1946.
 - Vertical Datum 1946.
 It is the contractors responsibility to locate all services that may be affected by his operations.
 - Pipe bedding: 0 10% granular bedding,10 20% weak concrete bedding.greater than 20% weak concrete bedding (7mpa plus anti scour blocks at 6m crs).
 - Each connection shall be marked by a 50mmx50mm treated pine stake extending 600mm above ground level with the top painted This marker post shall be placed alongside a timber marker installed at the time of pipelaying and extending from the connection to 150mm below finished ground level. Connections shall be accurately indicated on "as built" plans.
 - Approved hardfill is to be used in backfilling of all road crossings and vehicle crossings to council standards.
 - Heavy duty manhole lids and frames to be used in trafficked areas.
 - All Manholes are to be 1050mmØ unless shown otherwise
 - All cesspit leads shall have min cover 0.9m.
 - All lines to be abandoned shall be sealed at each end. timing of all sealing to be coordinated with

 J
 RFI
 JV
 04/2023

 I
 S92
 JV
 03/2023

 H
 S92
 JV
 01/2023

 G
 S92
 JV
 01/2023

 Rev
 Description
 By
 Date

 Survey
 SURVEYWORX
 12/21

 Design
 RK
 01/22


 Drawn
 RK
 01/22



62, 78 & 80 PAPAKURA - CLEVEDON ROAD, CLEVEDON, AUCKLAND FOR CLEVEDON PROPERTIES LTD

PROPOSED
WETLAND A & B
OUTLET CROSS SECTION

Project no.	194006			
Scale	NTS			
Cad file	C440- WETLAND.DWG			
Drawing no.	C444	Rev	J	

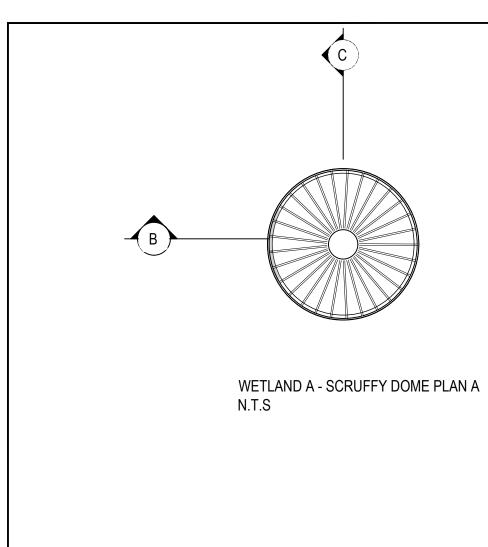

4.20m ON GOOD MATERIAL AND WELL HUNCHED WITH 0.5m WIDE CONCRETE BASE

ENGINEERING APPROVAL

PROPOSED WETLAND A OUTLET SECTION B



BUN60399307


Approved Resource Consent Plan

01/09/2023

PROPOSED WETLAND A OUTLET SECTION C

Note

- All works to be in accordance with Auckland council standards.
- Co-ordinates in terms of NZ Geodetic Datum Mt Eden 2000. Levels in terms of the Auckland Vertical Datum 1946.
- It is the contractors responsibility to locate all services that may be affected by his operations.
- Pipe bedding: 0 10% granular bedding,10 20% weak concrete bedding.greater than 20% weak concrete bedding (7mpa plus anti scour blocks at 6m crs).
- 5. Each connection shall be marked by a 50mmx50mm treated pine stake extending 600mm above ground level with the top painted. This marker post shall be placed alongside a timber marker installed at the time of pipelaying and extending from the connection to 150mm below finished ground level. Connections shall be accurately indicated on "as built" plans.
- Approved hardfill is to be used in backfilling of all road crossings and vehicle crossings to council standards.
- 7. Heavy duty manhole lids and frames to be used in trafficked areas.
- 8. All Manholes are to be 1050mmØ unless shown otherwise.
- All cesspit leads shall have min cover 0.9m.
- All lines to be abandoned shall be sealed at each end. timing of all sealing to be coordinated with council staff.

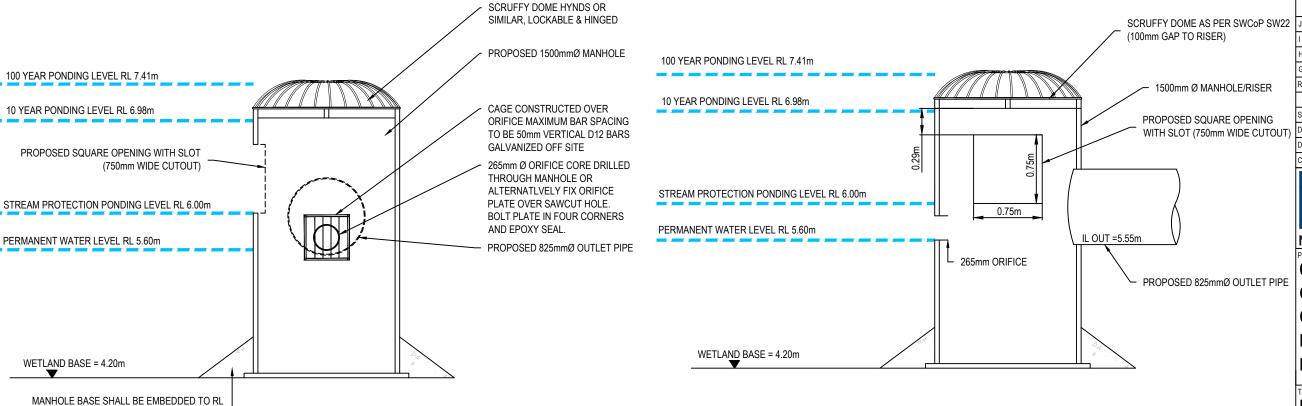

 J
 RFI
 JV
 04/2023

 I
 S92
 JV
 03/2023

 H
 S92
 JV
 01/2023

 G
 S92
 JV
 01/2023

 Rev
 Description
 By
 Date

 Survey
 SURVEYWORX
 12/21

 Design
 RK
 01/22

 Drawn
 RK
 05/22

 Checked
 JP
 05/22



62, 78 & 80 PAPAKURA CLEVEDON ROAD,
CLEVEDON, AUCKLAND
FOR CLEVEDON
PROPERTIES LTD

PROPOSED WETLAND A OUTLET DETAIL


 Project no.
 194006

 Scale
 NTS

 Cad file
 C440- WETLAND.DWG

 Drawing no.
 C445A

 Rev
 J

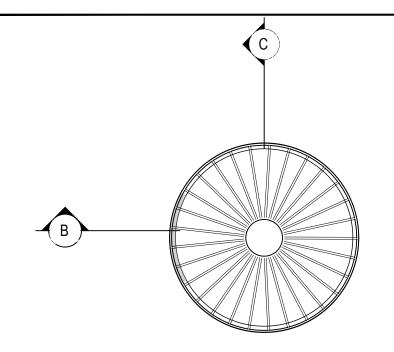

WETLAND B - SCRUFFY DOME PLAN A N.T.S

Auckland Council To Kauchde to Brown Maharar


BUN60399307

Approved Resource Consent Plan

01/09/2023

Notes

- All works to be in accordance with Auckland council standards.
- Co-ordinates in terms of NZ Geodetic Datum Mt Eden 2000. Levels in terms of the Auckland Vertical Datum 1946.
- It is the contractors responsibility to locate all services that may be affected by his operations.
- Pipe bedding: 0 10% granular bedding,10 -20% weak concrete bedding.greater than 20% weak concrete bedding (7mpa plus anti scour blocks at 6m crs).
- 5. Each connection shall be marked by a 50mmx50mm treated pine stake extending 600mm above ground level with the top painted. This marker post shall be placed alongside a timber marker installed at the time of pipelaying and extending from the connection to 150mm below finished ground level. Connections shall be accurately indicated on "as built" plans.
- Approved hardfill is to be used in backfilling of all road crossings and vehicle crossings to council standards.
- 7. Heavy duty manhole lids and frames to be used in trafficked areas.
- All Manholes are to be 1050mmØ unless shown otherwise.
- 9. All cesspit leads shall have min cover 0.9m.
- All lines to be abandoned shall be sealed at each end. timing of all sealing to be coordinated with council staff.

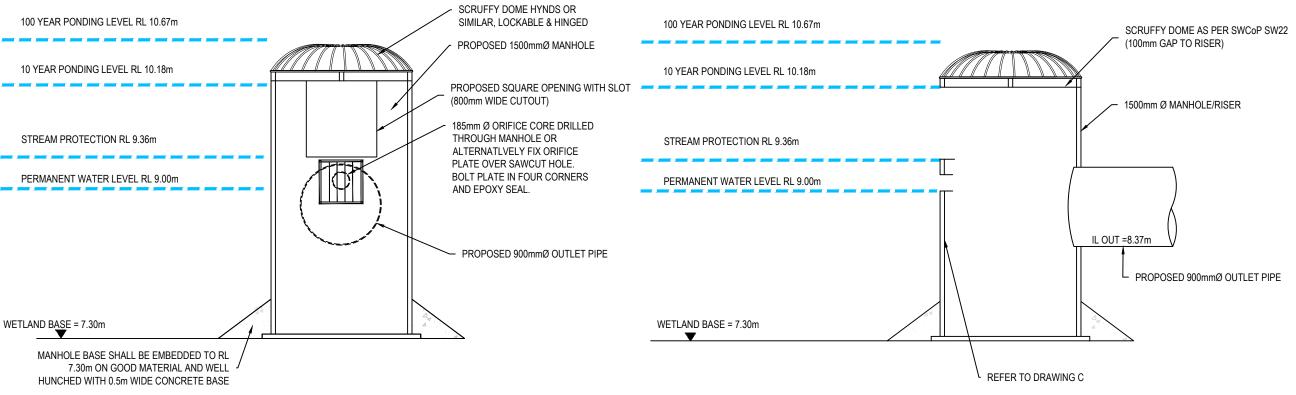

					JV	04/2023
					JV	03/2023
				JV	01/2023	
				JV	01/2023	
		ription			Ву	Date
		Ву		Date		
Surve	у	A	-	12/21 01/22		
Desig	n	RK				
Drawn		RK		05/22		
Checked		JP		05/22		




Project
62, 78 & 80 PAPAKURA CLEVEDON ROAD,
CLEVEDON, AUCKLAND
FOR CLEVEDON
PROPERTIES LTD

PROPOSED WETLAND B OUTLET DETAIL

Project no.	194006			
Scale	NTS			
Cad file	C440- WETLAND.DWG			
Drawing no.	C445B	Rev	J	

PROPOSED WETLAND B OUTLET SECTION B

PROPOSED WETLAND B OUTLET SECTION C

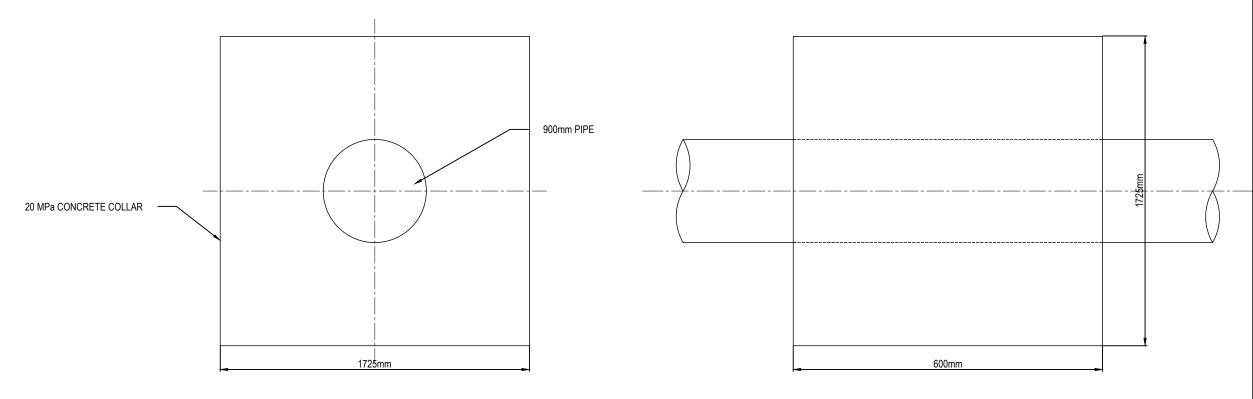


Auckland Council To Kaunhora o Tamah Masauran

BUN60399307

Approved Resource Consent Plan

01/09/2023

NOTES: THE OUTLET PIPE SHALL HAVE A WATERTIGHT ANTI-SEEP COLLAR MADE OF CONCRETE. THE COLLAR SHALL EXTEND VERTICALLY INSIDE THE POND BANKS AS DETAILED ON THE DRAWINGS. THE INLET SURROUNDS SHALL BE EXCAVATED TO THE REQUIRED DEPTH (AS SHOWN ON THE DRAWINGS) AND PREPARED FOR LINING. BIDIM A12 GEOTEXTILE SHALL BE INSTALLED AND PINNED IN PLACE AS PER MANUFACTURER'S INSTRUCTIONS, 300–500 MM RIP RAP TO BE PLACED ON THE GEOTEXTILE CAREFULLY SO AS NOT TO PERFORATE THE MATERIAL. RIP RAP SHALL BE PLACED AT A LEVEL GRADE; THE TOP OF RIP RAP TO BE THE SAME ELEVATION AS THE INLET INVERT AND RANDOMLY ARRANGED SO AS TO AVOID PREFERENTIAL FLOWPATHS.

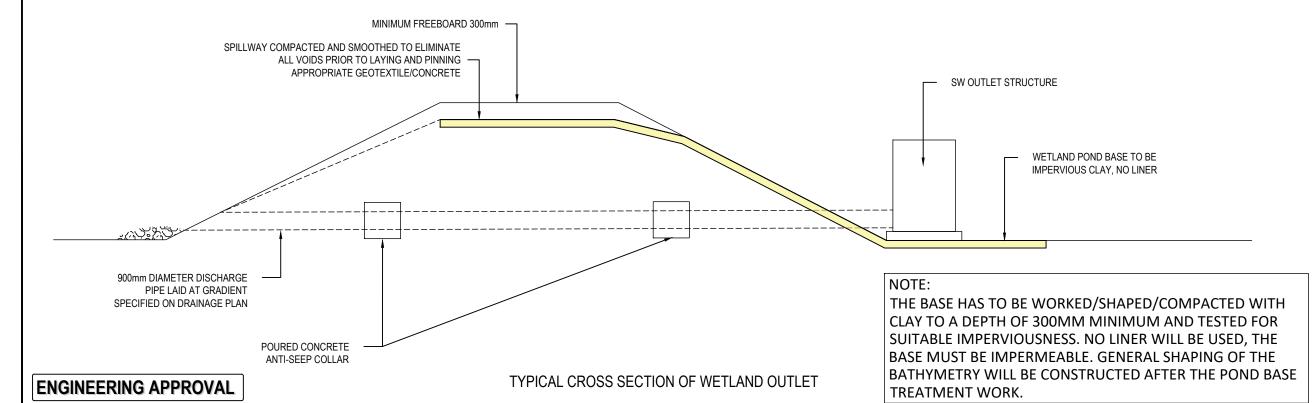

Note

- All works to be in accordance with Auckland council standards.
- Co-ordinates in terms of NZ Geodetic Datum Mt Eden 2000. Levels in terms of the Auckland Vertical Datum 1946.
- It is the contractors responsibility to locate all services that may be affected by his operations
- Pipe bedding: 0 10% granular bedding,10 20% weak concrete bedding.greater than 20% weak concrete bedding (7mpa plus anti scour blocks at 6m crs).
- Each connection shall be marked by a 50mmx50mm treated pine stake extending 600mm above ground level with the top painted This marker post shall be placed alongside a timber marker installed at the time of pipelaying and extending from the connection to 150mm below finished ground level. Connections shall be accurately indicated on "as built" plans.
- Approved hardfill is to be used in backfilling of all road crossings and vehicle crossings to council standards.
- 7. Heavy duty manhole lids and frames to be used in trafficked areas.
- All Manholes are to be 1050mmØ unless showr otherwise.
- 9. All cesspit leads shall have min cover 0.9m.
- All lines to be abandoned shall be sealed at each end. timing of all sealing to be coordinated with council staff.

I S92				JV	04/2023	
				JV	03/2023	
Н	S92			JV	01/2023	
G	G S92			JV	01/2023	
Rev	Desc	ription	By Date		Date	
		Ву	Date			
Surve	y	SURVEYWORX	12/21	12/21		
Desigr	n	RK	01/22			
Drawn		RK	05/22		·	
Check	ed	JP	05/22			




62, 78 & 80 PAPAKURA CLEVEDON ROAD,
CLEVEDON, AUCKLAND
FOR CLEVEDON
PROPERTIES LTD

Title

PROPOSED WETLAND AND ANTI-SEEP COLLAR DETAIL


Project no.	194006				
Scale	NTS				
Cad file	C440- WETLAND.DWG				
Drawing no.	C445C	Rev	J		

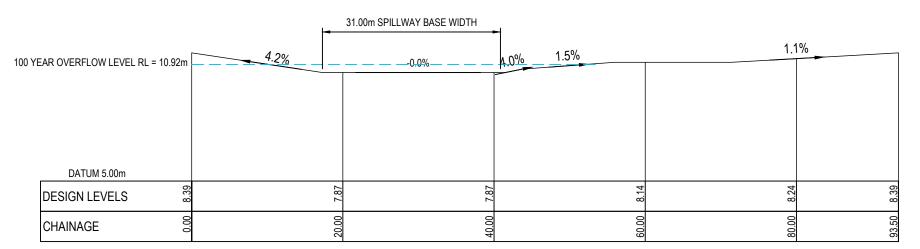

WETLAND A SPILLWAY LONGSECTION SCALE 1:500 @ A3

Auckland Council
BUN60399307

Approved Resource Consent Plan
01/09/2023

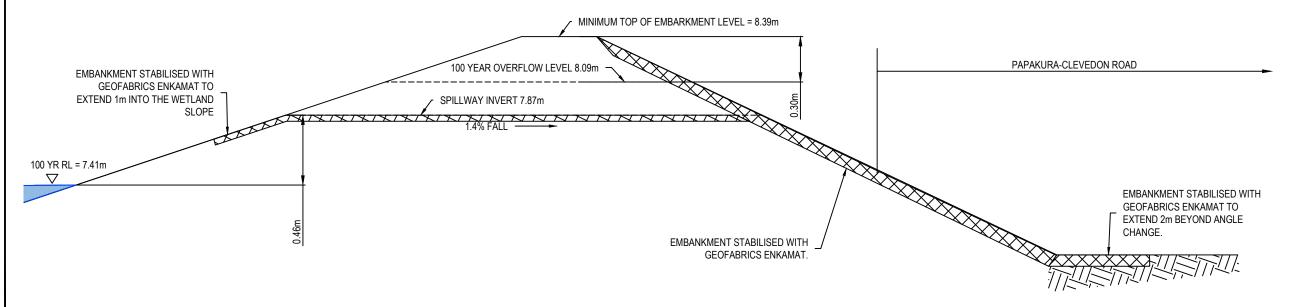

WETLAND A SPILLWAY CROSS SECTION

ENGINEERING APPROVAL

lotes

- All works to be in accordance with Auckland council standards.
- Co-ordinates in terms of NZ Geodetic Datum Mt Eden 2000. Levels in terms of the Auckland Vertical Datum 1946.
- It is the contractors responsibility to locate all services that may be affected by his operations.
- Pipe bedding: 0 10% granular bedding;10 20% weak concrete bedding.greater than 20% weak concrete bedding (7mpa plus anti scour blocks at 6m crs).
- 5. Each connection shall be marked by a 50mmx50mm treated pine stake extending 600mm above ground level with the top painted. This marker post shall be placed alongside a timber marker installed at the time of pipelaying and extending from the connection to 150mm below finished ground level. Connections shall be accurately indicated on "as built" plans.
- Approved hardfill is to be used in backfilling of all road crossings and vehicle crossings to council standards.
- 7. Heavy duty manhole lids and frames to be used in trafficked areas.
- 8. All Manholes are to be 1050mmØ unless shown otherwise.
- All cesspit leads shall have min cover 0.9m.
- All lines to be abandoned shall be sealed at each end. timing of all sealing to be coordinated with council staff.

	J	RFI			JV	04/2023	
	I	S92			JV	03/2023	
	Н	S92			JV	01/2023	
	G	S92				01/2023	
	Rev	Desc	cription		Ву	Date	
			Ву	Date			
	Surve	y	SURVEYWORX	12/21	12/21		
	Design Drawn		RK	01/22			
			RK	05/22			
	Check	ed	JP	05/22		•	



62, 78 & 80 PAPAKURA CLEVEDON ROAD,
CLEVEDON, AUCKLAND
FOR CLEVEDON
PROPERTIES LTD

PROPOSED
WETLAND A
SPILLWAY DETAIL


Project no.	194006				
Scale	NTS				
Cad file	C440- WETLAND.DWG				
Drawing no.	C445D	Rev	J		




BUN60399307

Approved Resource Consent Plan

01/09/2023

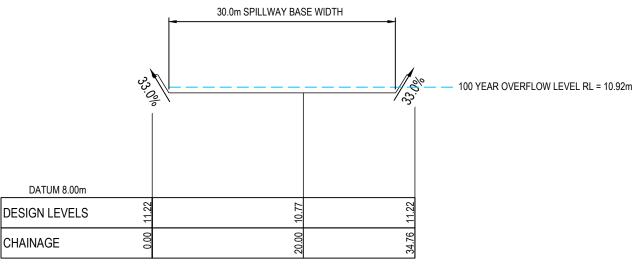

WETLAND B SPILLWAY LONGSECTION SCALE 1:500 @ A3

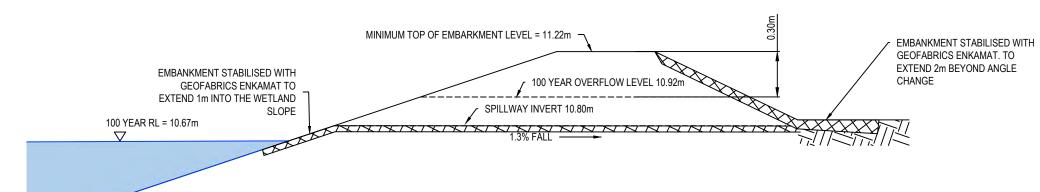

WETLAND B SPILLWAY CROSS SECTION N.T.S

- All works to be in accordance with Auckland council standards.
- Co-ordinates in terms of NZ Geodetic Datum Mt Eden 2000. Levels in terms of the Auckland Vertical Datum 1946.
- . It is the contractors responsibility to locate all services that may be affected by his operations.
- Pipe bedding: 0 10% granular bedding,10 -20% weak concrete bedding.greater than 20% weak concrete bedding (7mpa plus anti scour blocks at 6m crs).
- Each connection shall be marked by a 50mmx50mm treated pine stake extending 600mm above ground level with the top painted This marker post shall be placed alongside a timber marker installed at the time of pipelaying and extending from the connection to 150mm below finished ground level. Connections shall be accurately indicated on "as built" plans.
- Approved hardfill is to be used in backfilling of all road crossings and vehicle crossings to council standards.
- Heavy duty manhole lids and frames to be used in trafficked areas.
- All Manholes are to be 1050mmØ unless shown otherwise.
- 9. All cesspit leads shall have min cover 0.9m.
- 0. All lines to be abandoned shall be sealed at each end. timing of all sealing to be coordinated with council staff.


J RFI I S92				JV	04/2023	
				JV	03/2023	
Н	S92			JV	01/2023	
G	S92				01/2023	
Rev	Desc	ription		Ву	Date	
		Ву	Date	Date 12/21		
Surve	у	SURVEYWORX	12/21			
Design		RK	01/22	01/22		
Drawr	ı	RK	05/22			
Charl		ID.	05/00	05/00		




62, 78 & 80 PAPAKURA -**CLEVEDON ROAD,** CLEVEDON, AUCKLAND **FOR CLEVEDON PROPERTIES LTD**

PROPOSED WETLAND B SPILLWAY DETAIL

Project no.	194006		
Scale	NTS		
Cad file	C440- WETLAND.DWG		
Drawing no.	C445E	Rev	J

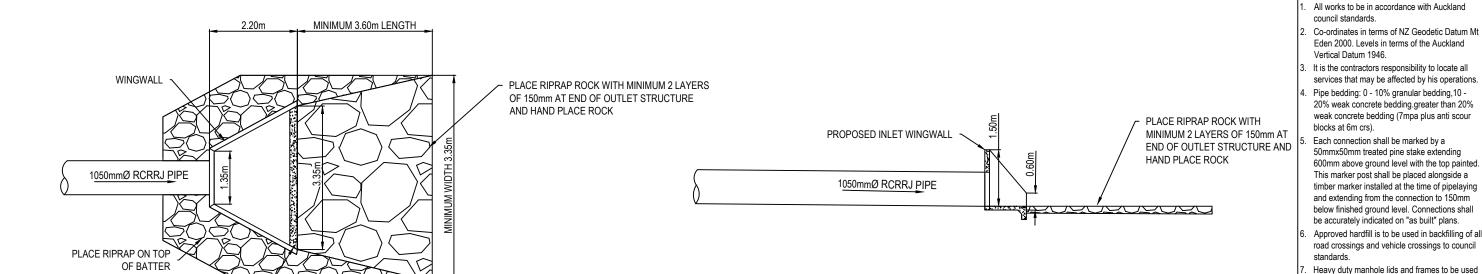

WETLAND A INLET DETAIL - OUTLET 1-0 SCALE 1:100 @ A3

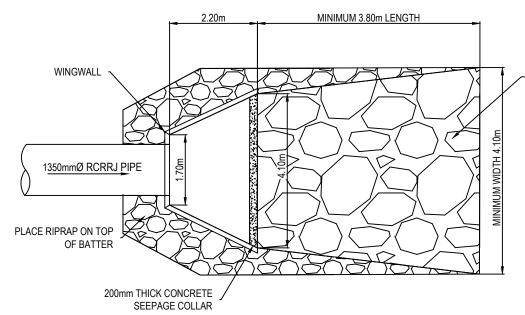

200mm THICK CONCRETE SEEPAGE COLLAR

ENGINEERING APPROVAL

PLACE RIPRAP ROCK WITH MINIMUM 2 LAYERS OF 170mm AT END OF OUTLET STRUCTURE AND HAND PLACE ROCK

PROPOSED INLET WINGWALL 1350mmØ RCRRJ PIPE

PLACE RIPRAP ROCK WITH AND HAND PLACE ROCK

MINIMUM 2 LAYERS OF 170mm AT END OF OUTLET STRUCTURE

> 03/2023 S92 S92 01/2023 01/2023 G S92 JV Date 12/21 01/22 05/22

04/2023

in trafficked areas.

otherwise.

council staff.

All Manholes are to be 1050mmØ unless shown

All cesspit leads shall have min cover 0.9m.

0. All lines to be abandoned shall be sealed at each end. timing of all sealing to be coordinated with




62, 78 & 80 PAPAKURA -**CLEVEDON ROAD, CLEVEDON, AUCKLAND** FOR CLEVEDON **PROPERTIES LTD**

PROPOSED WETLAND INLET DETAIL SECTIONS


194006 Project no. NTS Cad file C440- WETLAND.DWG C445F

WETLAND B INLET DETAIL - OUTLET 2-0 SCALE 1:100 @ A3


> Auckland Council BUN60399307 Approved Resource Consent Plan 01/09/2023

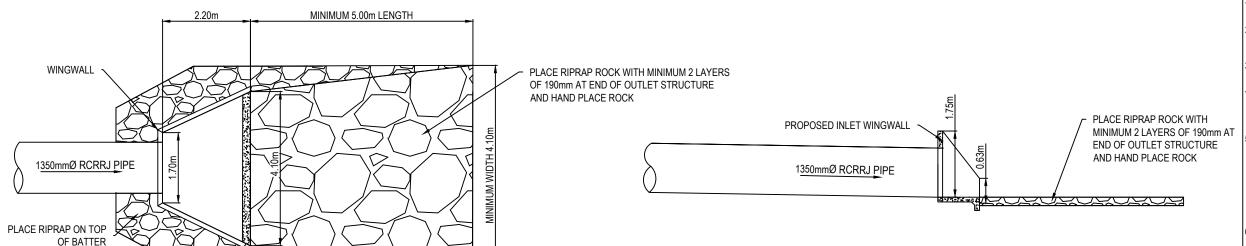


WETLAND B INLET DETAIL - OUTLET 4-0 SCALE 1:100 @ A3

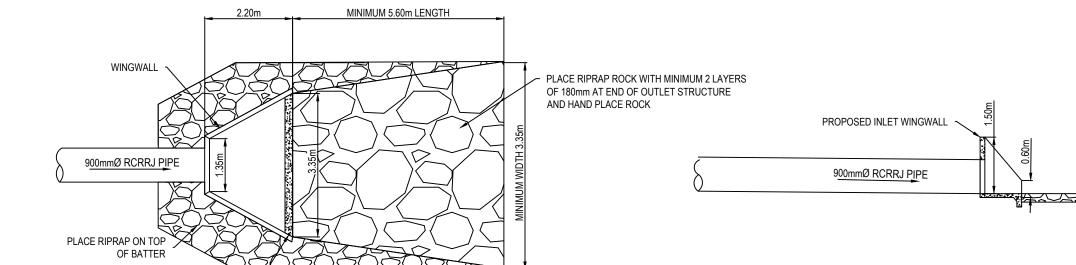

WETLAND B INLET DETAIL - OUTLET 2
SCALE 1:100 @ A3

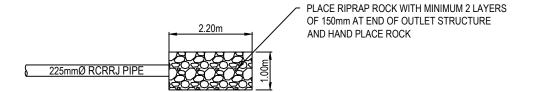

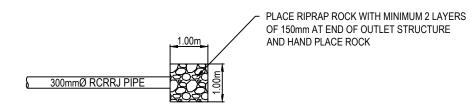

WETLAND B INLET DETAIL - OUTLET 6-0 SCALE 1:100 @ A3

Auckland Council

BUN60399307

Approved Resource Consent Plan

01/09/2023

PLACE RIPRAP ROCK WITH

MINIMUM 2 LAYERS OF 180mm

AT END OF OUTLET STRUCTURE AND HAND PLACE ROCK

Notes

- All works to be in accordance with Auckland council standards.
- Co-ordinates in terms of NZ Geodetic Datum Mt Eden 2000. Levels in terms of the Auckland Vertical Datum 1946.
- It is the contractors responsibility to locate all services that may be affected by his operations.
- Pipe bedding: 0 10% granular bedding,10 -20% weak concrete bedding.greater than 20% weak concrete bedding (7mpa plus anti scour blocks at 6m crs).
- 5. Each connection shall be marked by a
 50mmx50mm treated pine stake extending
 600mm above ground level with the top painted
 This marker post shall be placed alongside a
 timber marker installed at the time of pipelaying
 and extending from the connection to 150mm
 below finished ground level. Connections shall
 be accurately indicated on "as built" plans.
- Approved hardfill is to be used in backfilling of all road crossings and vehicle crossings to council standards.
- 7. Heavy duty manhole lids and frames to be used in trafficked areas.
- 8. All Manholes are to be 1050mmØ unless shown otherwise.
- All cesspit leads shall have min cover 0.9m
- All lines to be abandoned shall be sealed at each end. timing of all sealing to be coordinated with council staff.

J	RFI			JV	04/2023
I	S92	S92			03/2023
Н	S92			JV	01/2023
G	S92			JV	01/2023
Rev	Desc	ription		Ву	Date
		Ву	Date		
Surve	Survey SURVEYWORX 12/21				
Design	n	RK	01/22		
Drawn	1	RK 05/22			
Check	ed	JP	05/22		



62, 78 & 80 PAPAKURA CLEVEDON ROAD,
CLEVEDON, AUCKLAND
FOR CLEVEDON
PROPERTIES LTD

PROPOSED
WETLAND INLET DETAIL
SECTIONS

 Project no.
 194006

 Scale
 NTS

 Cad file
 C440- WETLAND.DWG

 Drawing no.
 C445G

 Rev
 J

WETLAND A INLET DETAIL - OUTLET 7-0


ENGINEERING APPROVAL SCALE 1:100 @ A3

200mm THICK CONCRETE


SEEPAGE COLLAR

200mm THICK CONCRETE

SEEPAGE COLLAR

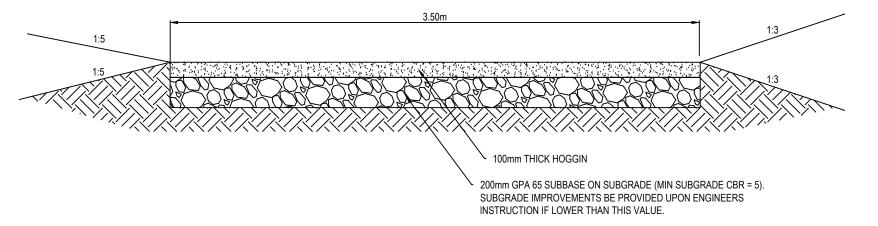

POND MAINTANENCE ACCESS TRACK SCALE 1:25

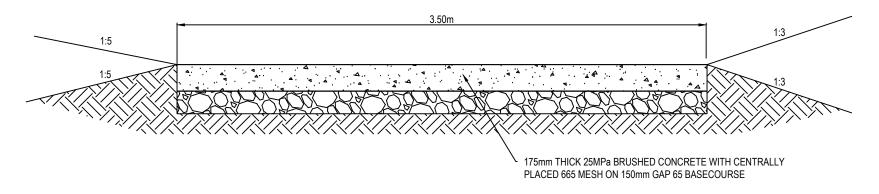

POND SHARED PATH SCALE 1:25

Auckland Council

Approved Resource Consent Plan

01/09/2023

Notes

- All works to be in accordance with Auckland council standards.
- Co-ordinates in terms of NZ Geodetic Datum Mt Eden 2000. Levels in terms of the Auckland Vertical Datum 1946.
- It is the contractors responsibility to locate all services that may be affected by his operations.
- Pipe bedding: 0 10% granular bedding,10 20% weak concrete bedding.greater than 20% weak concrete bedding (7mpa plus anti scour blocks at 6m crs).
 - Each connection shall be marked by a 50mmx50mm treated pine stake extending 600mm above ground level with the top painted This marker post shall be placed alongside a timber marker installed at the time of pipelaying and extending from the connection to 150mm below finished ground level. Connections shall be accurately indicated on "as built" plans.
- Approved hardfill is to be used in backfilling of all road crossings and vehicle crossings to council standards.
- 7. Heavy duty manhole lids and frames to be used in trafficked areas.
- All Manholes are to be 1050mmØ unless shown otherwise.
- 9. All cesspit leads shall have min cover 0.9m.
- All lines to be abandoned shall be sealed at each end. timing of all sealing to be coordinated with council staff.

J	RFI	RFI			04/2023
I	S92	592		JV	03/2023
Н	S92			JV	01/2023
G	S92			JV	01/2023
Rev	Desc	ription		Ву	Date
		Ву	Date		
Survey		SURVEYWORX	12/21	2/21	
Design		RK	01/22		
Drawi	1	RK	05/22		
	01 1 1 10		٥٥٥٥		



62, 78 & 80 PAPAKURA CLEVEDON ROAD,
CLEVEDON, AUCKLAND
FOR CLEVEDON
PROPERTIES LTD

PROPOSED
ACCESS ROAD
CROSS-SECTION


 Project no.
 194006


 Scale
 NTS

 Cad file
 C440- WETLAND.DWG

 Drawing no.
 C4451

 Rev
 J

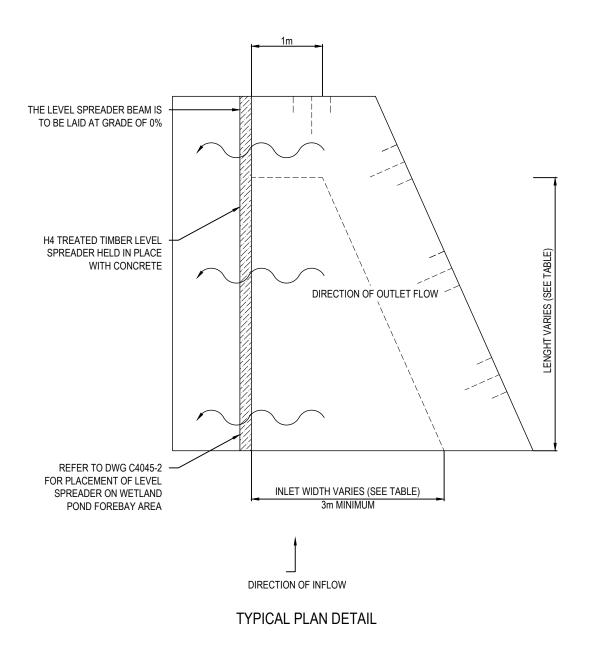

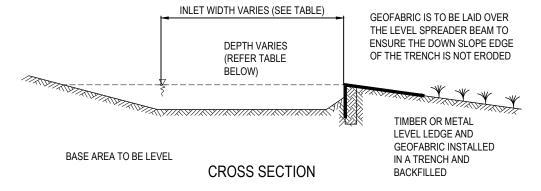

LEVEL SPREADER

TABLE 1: LEVEL SPREADER DESIGN CRITERIA:

DESIGN FLOW (m³/sec)	INLET WIDTH (m)	DEPTH (mm)	END WIDTH (m)	LENGTH (m)
0 - 0.3	3	150	1	3
0.3 - 0.6	5	180	1	7
0.6 - 0.9	7	220	1	10

NOTES: A LEVEL SPREADER WEIR IS REQUIRED ON THE FOREBAY BUND (CAN BE A PRECAST CONCRETE BEAM). THIS IS DESIGNED TO SPREAD THE FLOWS EVENLY ACROSS THE FULL WIDTH OF THE WETLAND AND REDUCE THE RISKS OF PREFERENTIAL FLOW PATHS. DRAWINGS OF LEVEL SPREADER SHOULD INDICATE THAT IT WILL WELL KEYED INTO THE BATTERS (BY AT LEAST 500 MM) TO PREVENT ANY SHORT CIRCUITS FORMING RESULTING IN PREFERENTIAL FLOW PATHS AND PERSISTENT SCOUR OR PIPING.

Auckland Council

BUN60399307

Approved Resource Consent Plan

01/09/2023

Note

- All works to be in accordance with Auckland council standards.
- . Co-ordinates in terms of NZ Geodetic Datum Mt Eden 2000. Levels in terms of the Auckland Vertical Datum 1946.
- It is the contractors responsibility to locate all services that may be affected by his operations.
- Pipe bedding: 0 10% granular bedding,10 20% weak concrete bedding.greater than 20% weak concrete bedding (7mpa plus anti scour blocks at 6m crs).
- . Each connection shall be marked by a 50mmx50mm treated pine stake extending 600mm above ground level with the top painted This marker post shall be placed alongside a timber marker installed at the time of pipelaying and extending from the connection to 150mm below finished ground level. Connections shall be accurately indicated on "as built" plans.
- Approved hardfill is to be used in backfilling of all road crossings and vehicle crossings to council standards.
- 7. Heavy duty manhole lids and frames to be used in trafficked areas.
- 8. All Manholes are to be 1050mmØ unless shown
- 9. All cesspit leads shall have min cover 0.9m.
- All lines to be abandoned shall be sealed at each end. timing of all sealing to be coordinated with council staff.

J	RFI			JV	04/2023
I	S92	S92		JV	03/2023
Н	S92	S92		JV	01/2023
G	S92	S92		JV	01/2023
Rev	Desc	scription		Ву	Date
		Ву	Date		
Survey		SURVEYWORX	12/21	12/21	
Design		RK	01/22	01/22	
Drawn		RK	05/22	05/22	
Checked		JP	05/22	!	





62, 78 & 80 PAPAKURA CLEVEDON ROAD,
CLEVEDON, AUCKLAND
FOR CLEVEDON
PROPERTIES LTD


Title

PROPOSED
WETLAND
LEVEL SPREADER DETAIL

Project no.	194006		
Scale	NTS		
Cad file	C440- WETLAND.DWG		
Drawing no.	C445J	Rev	J

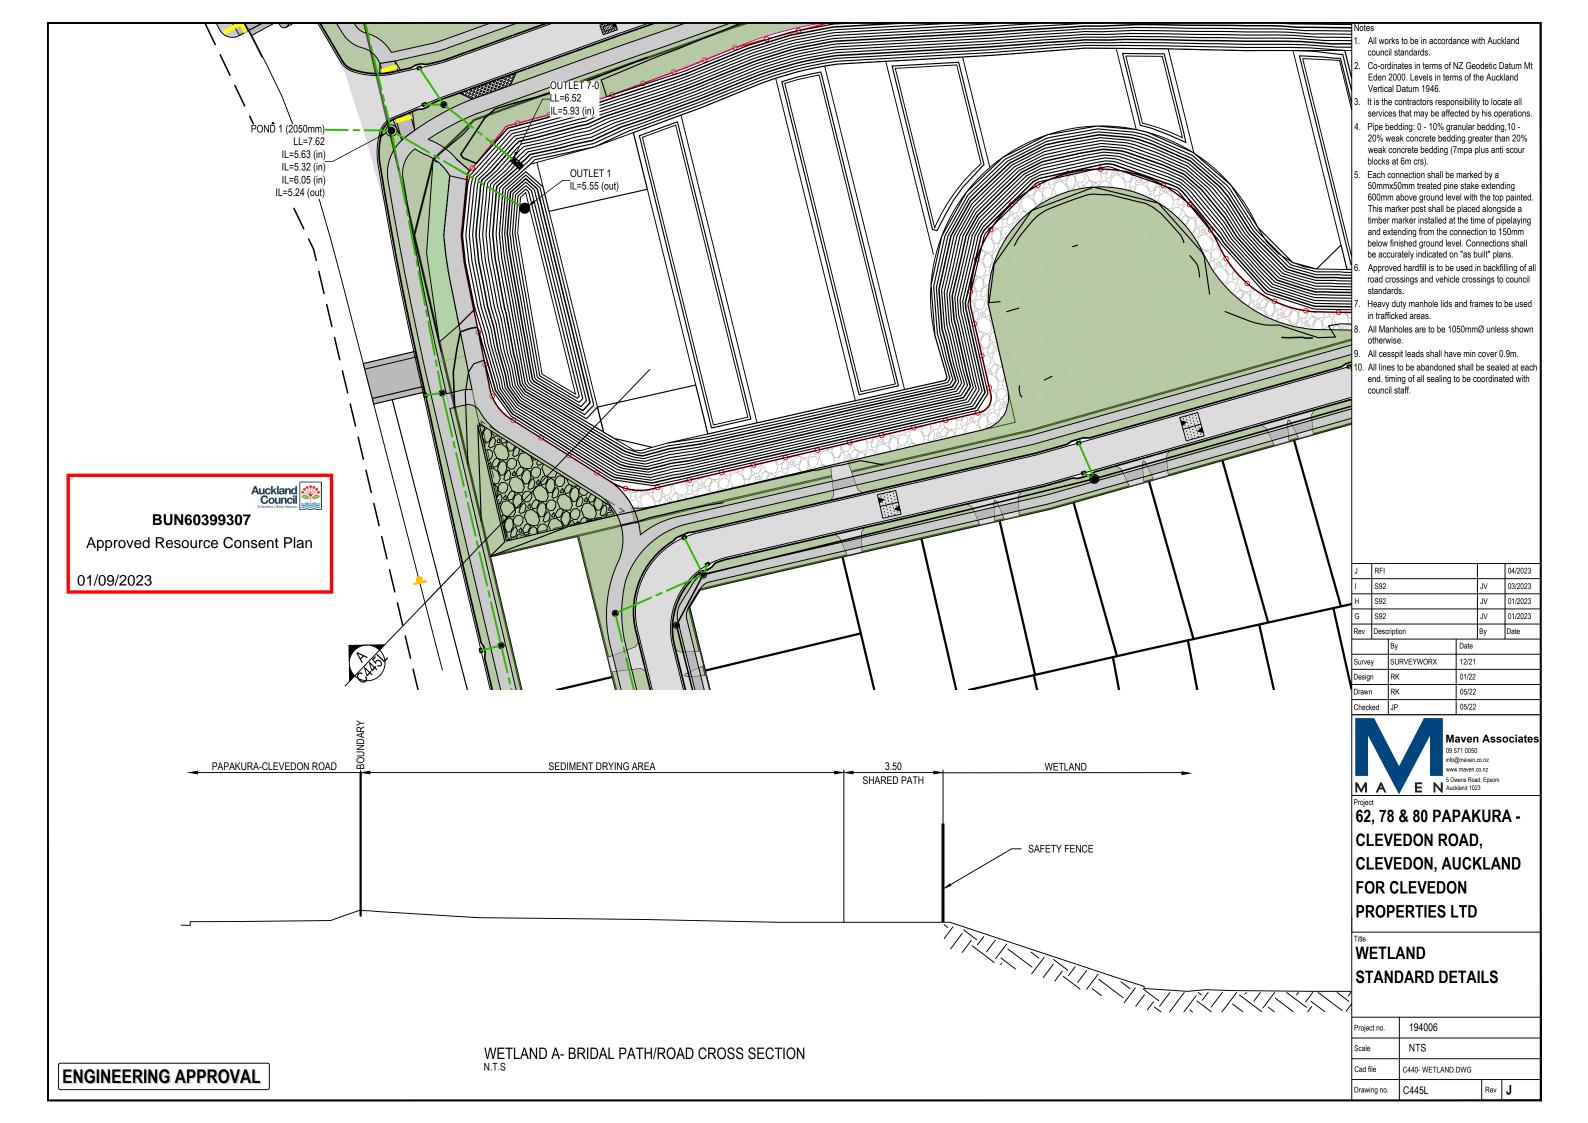


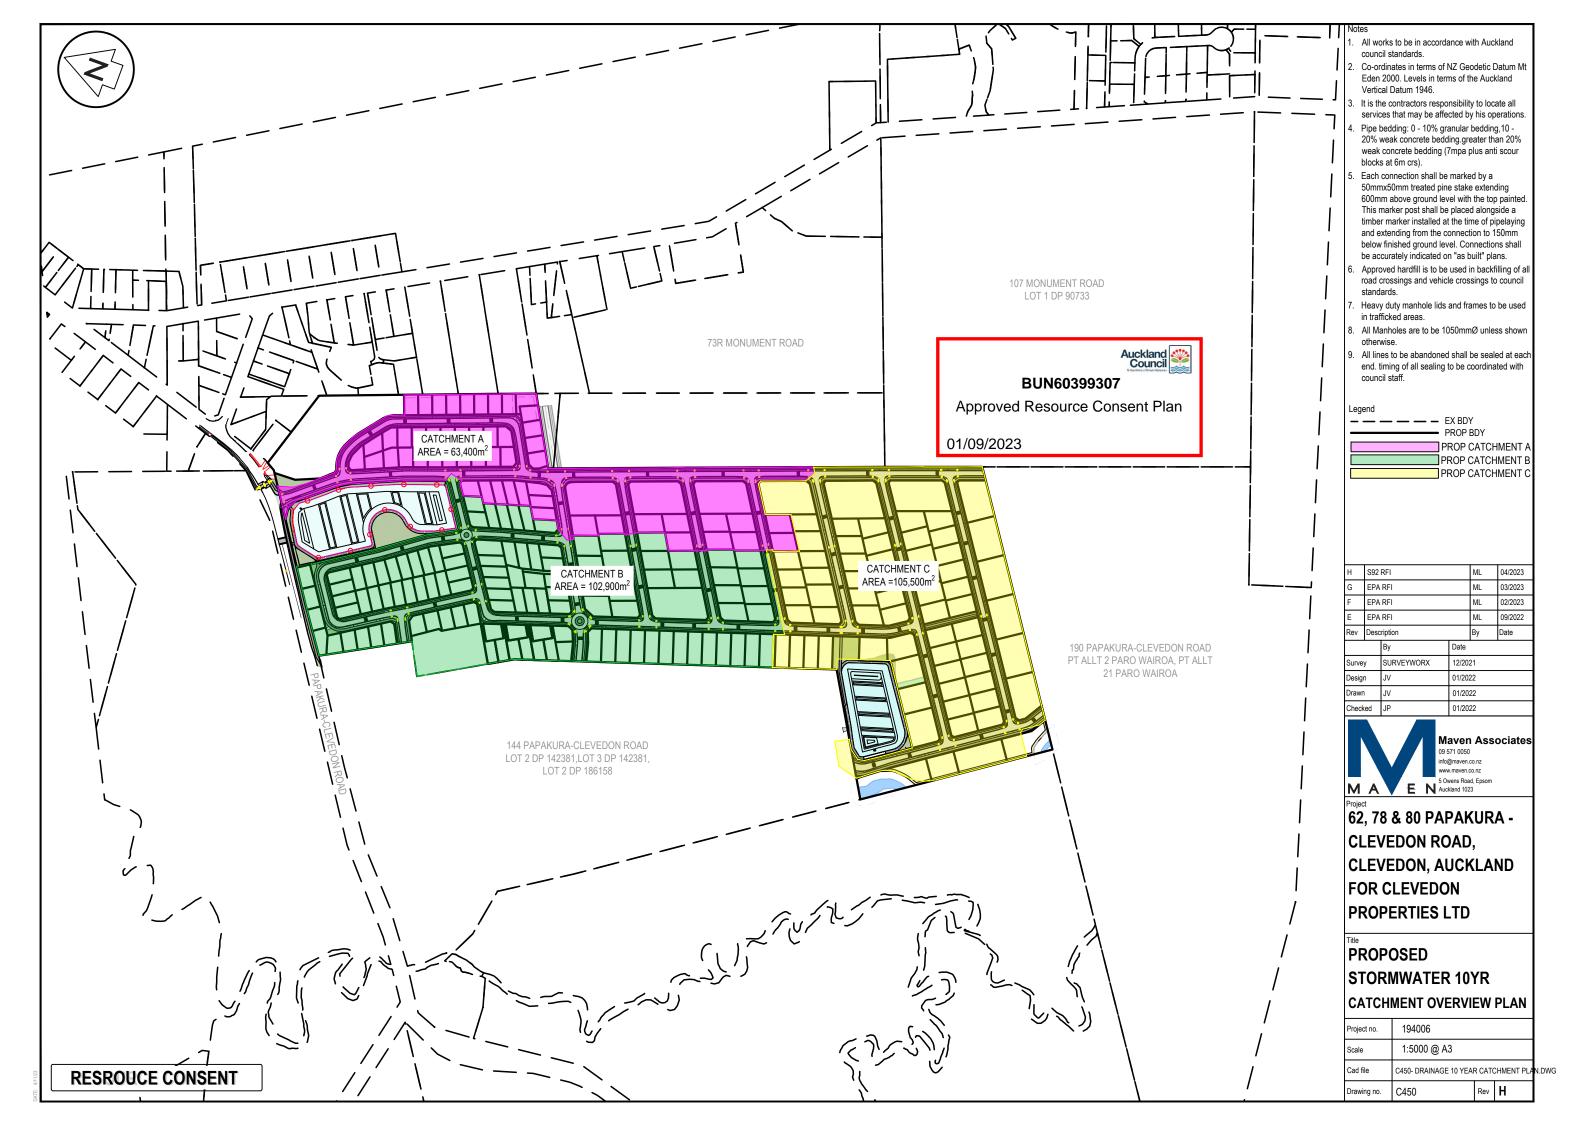


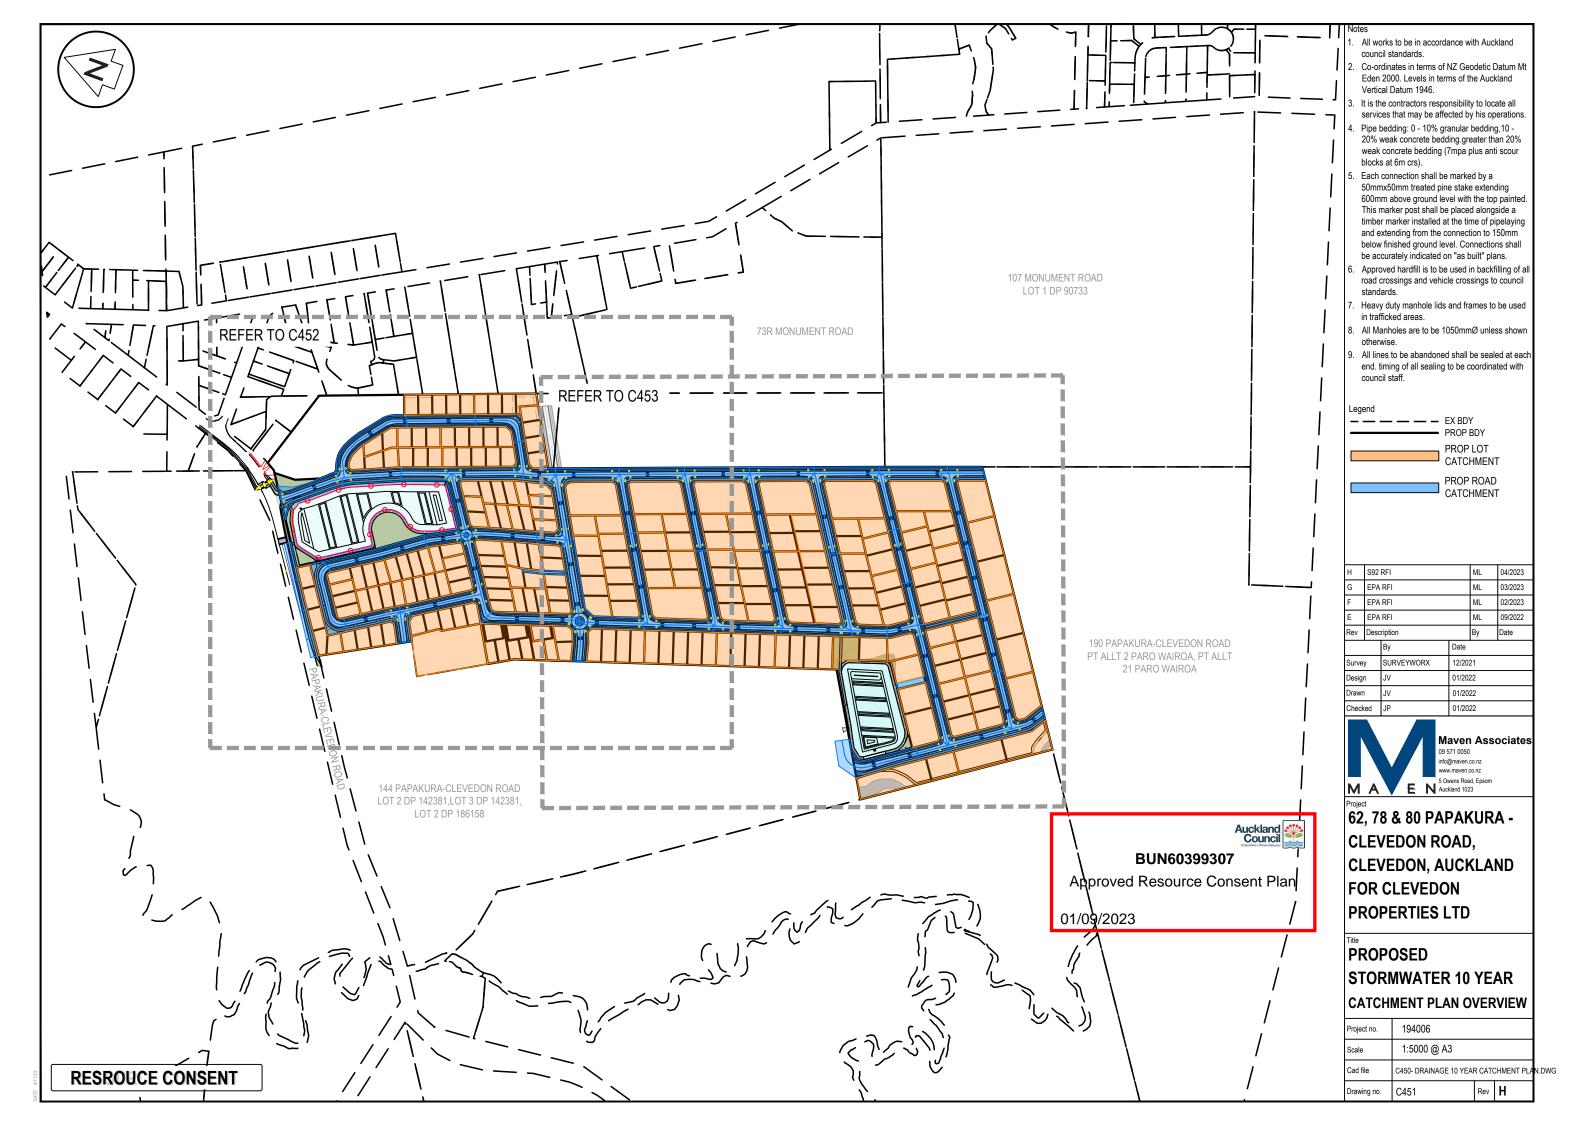








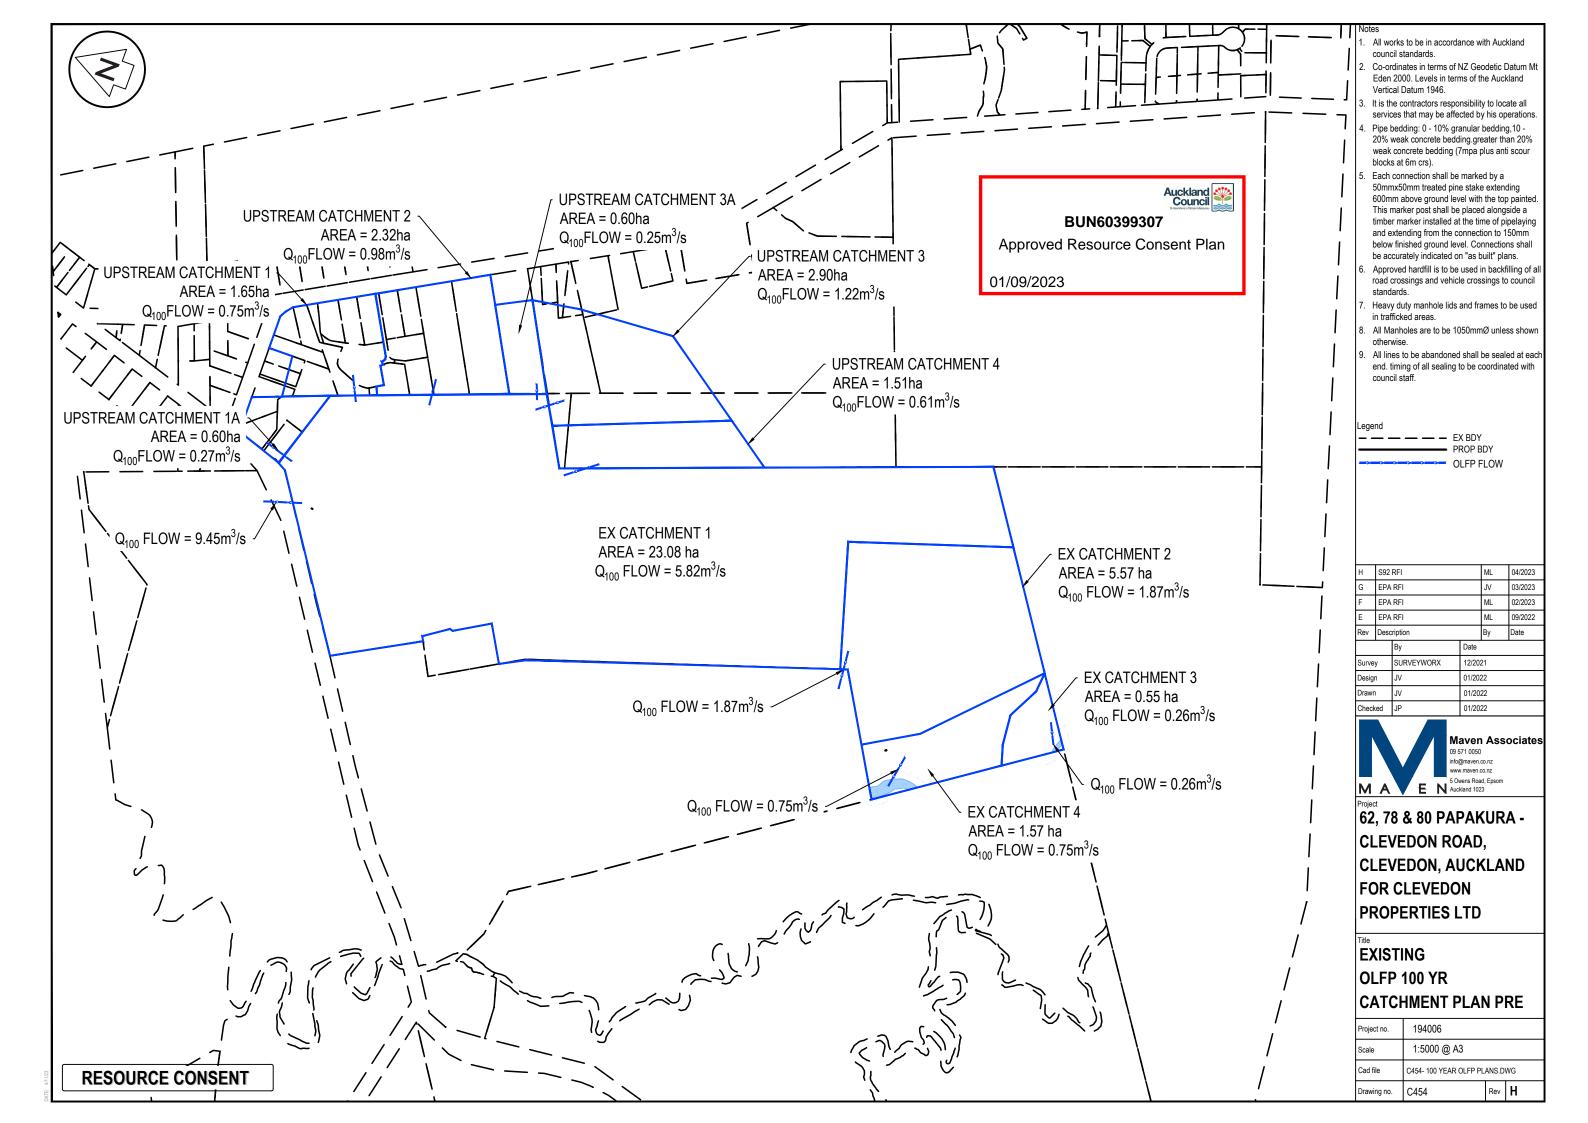

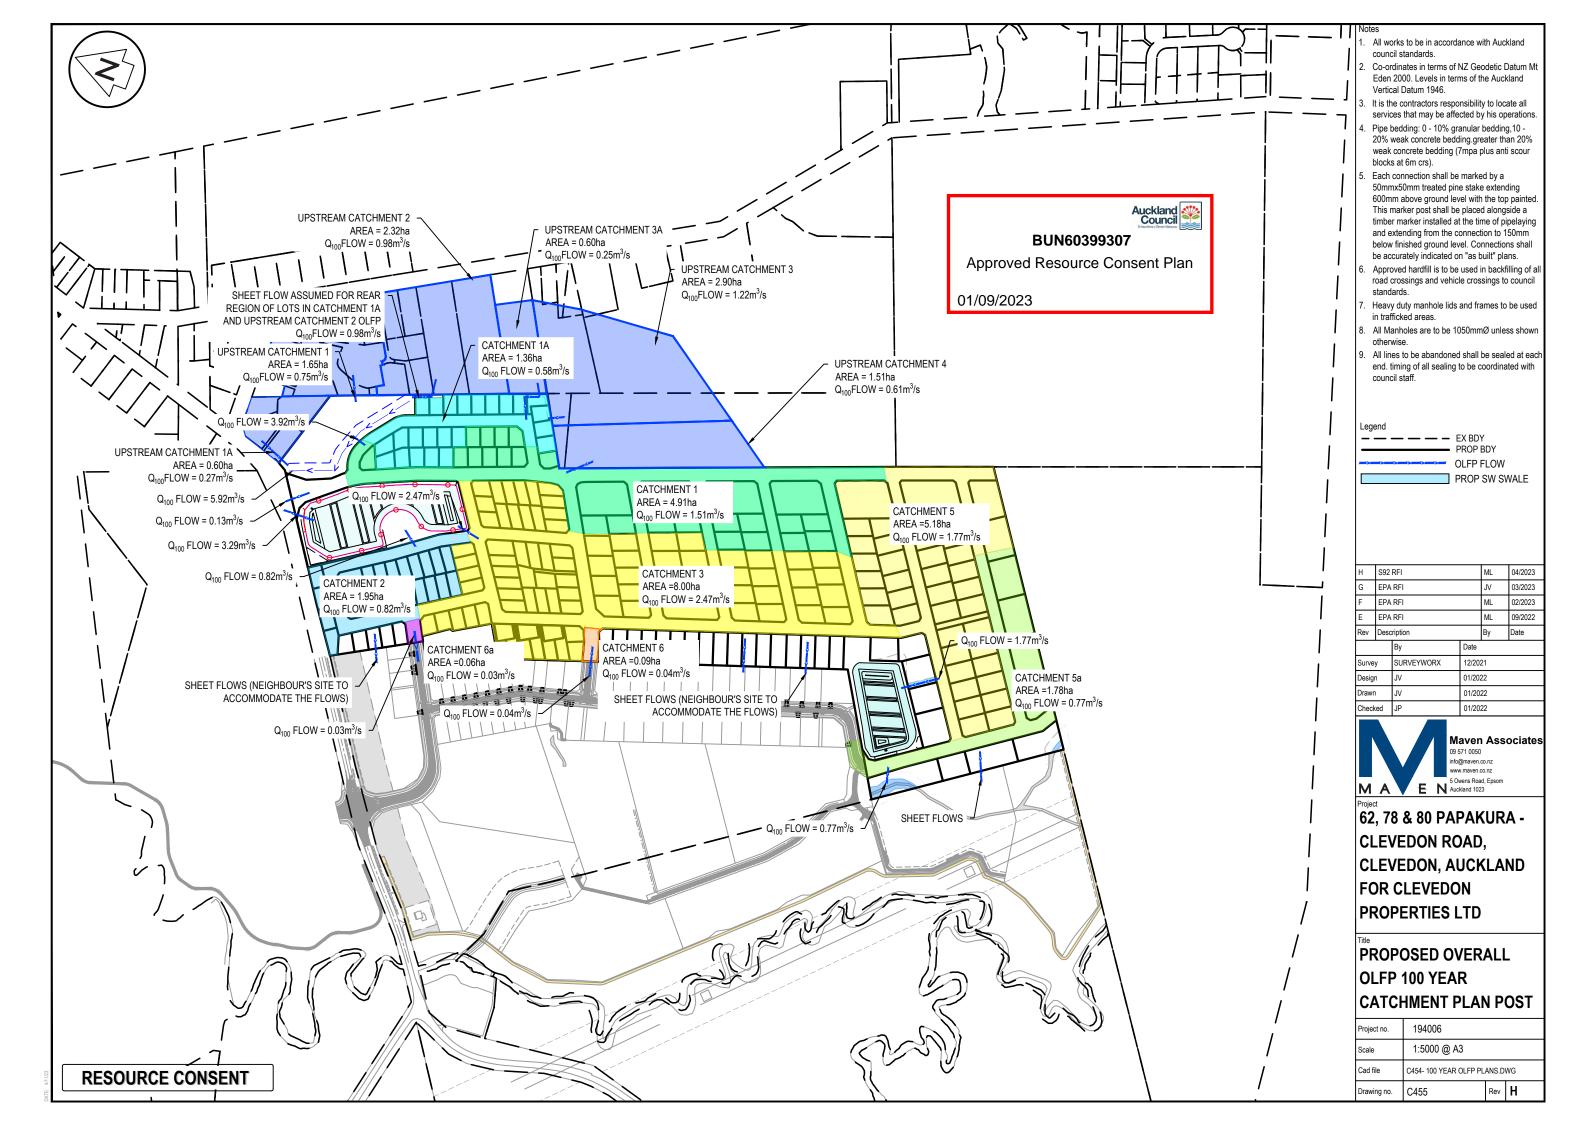

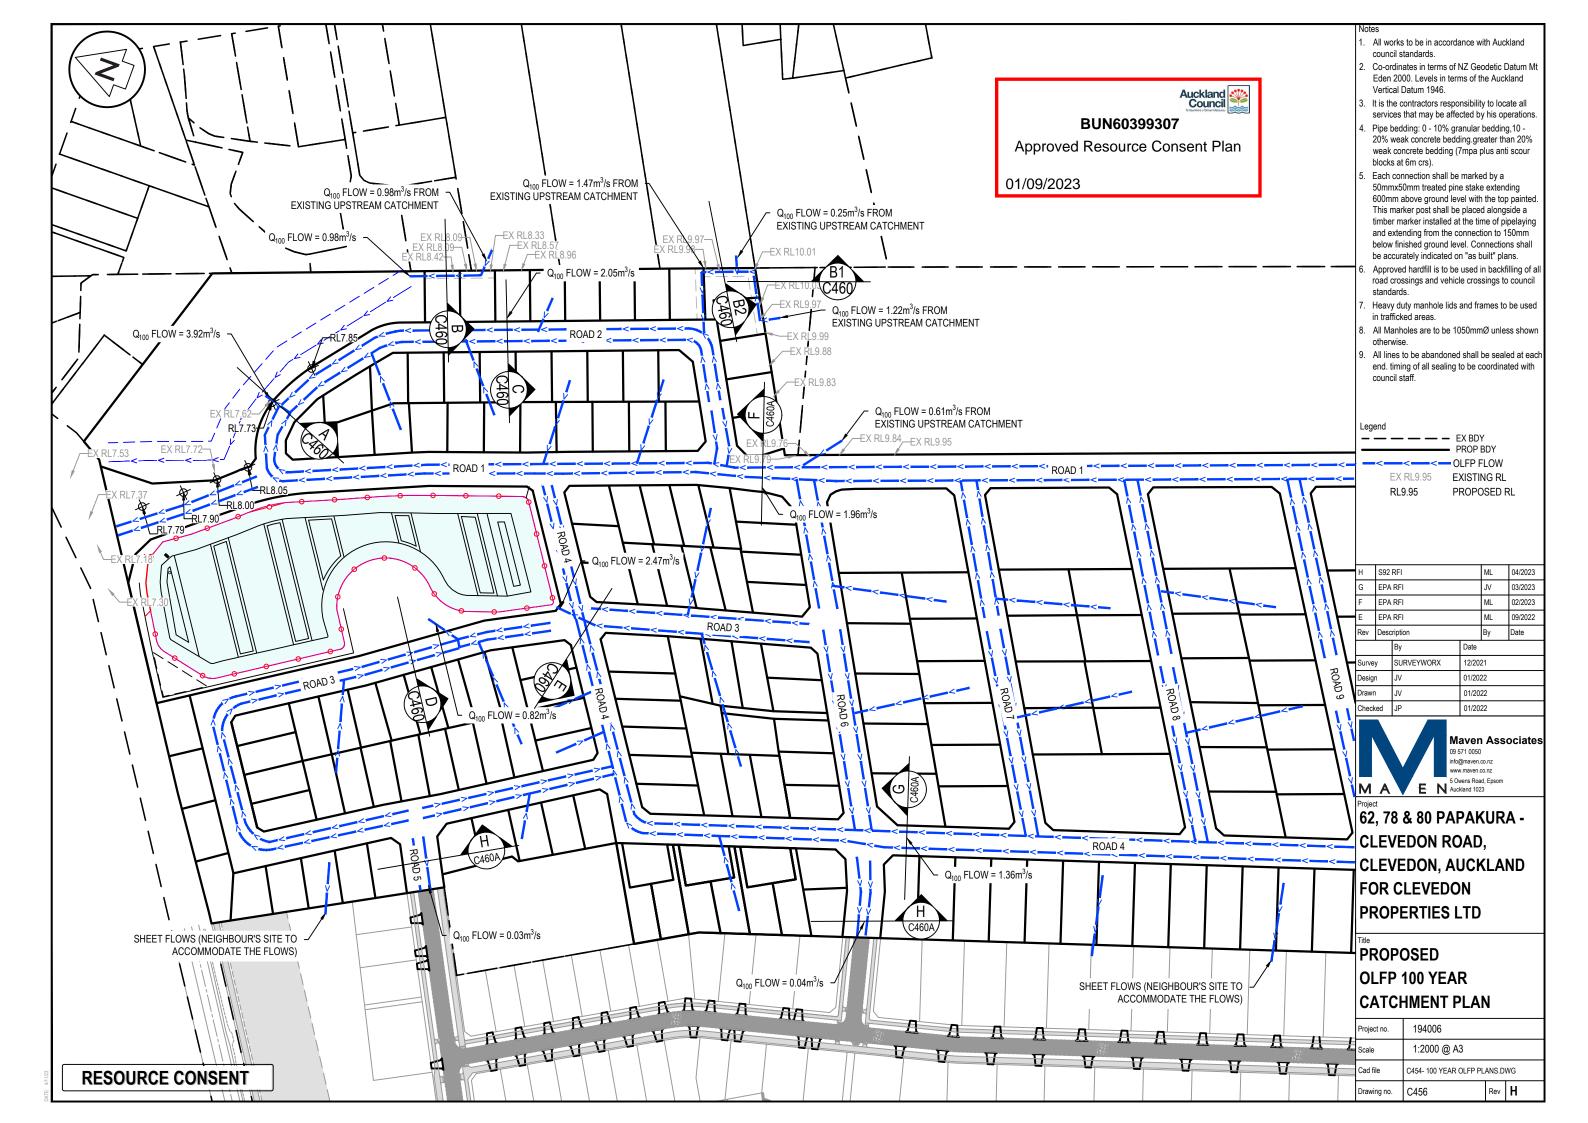

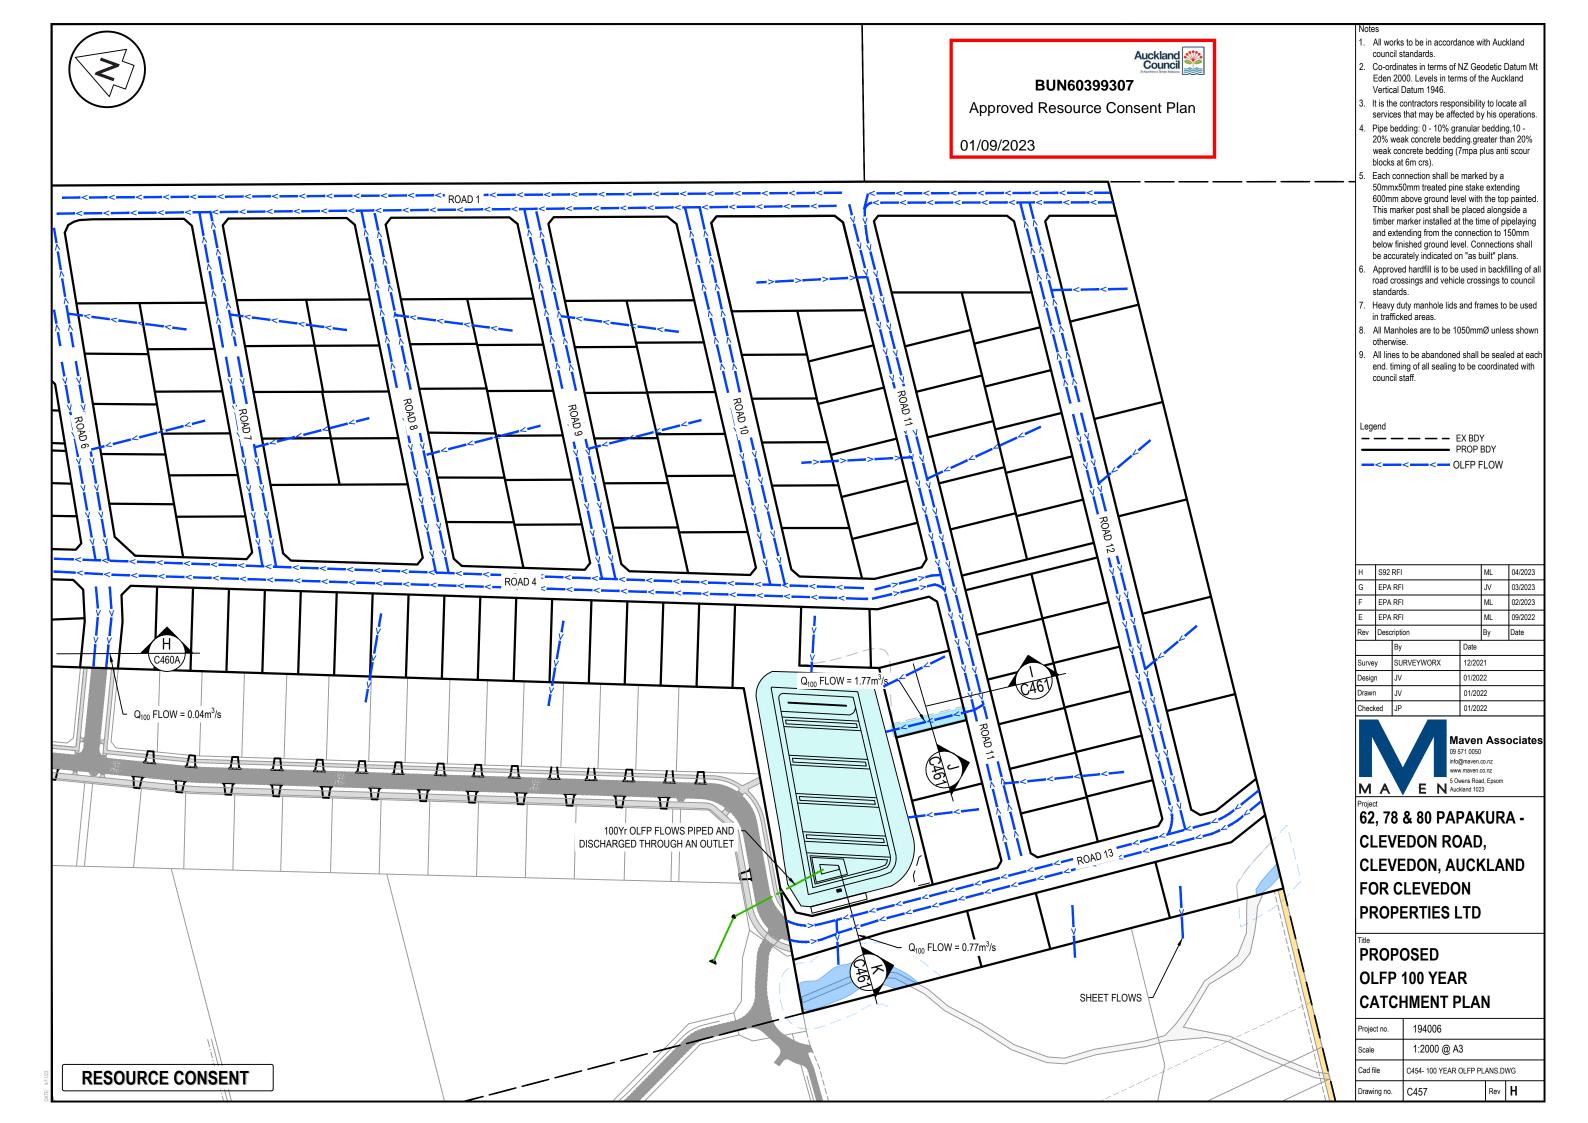

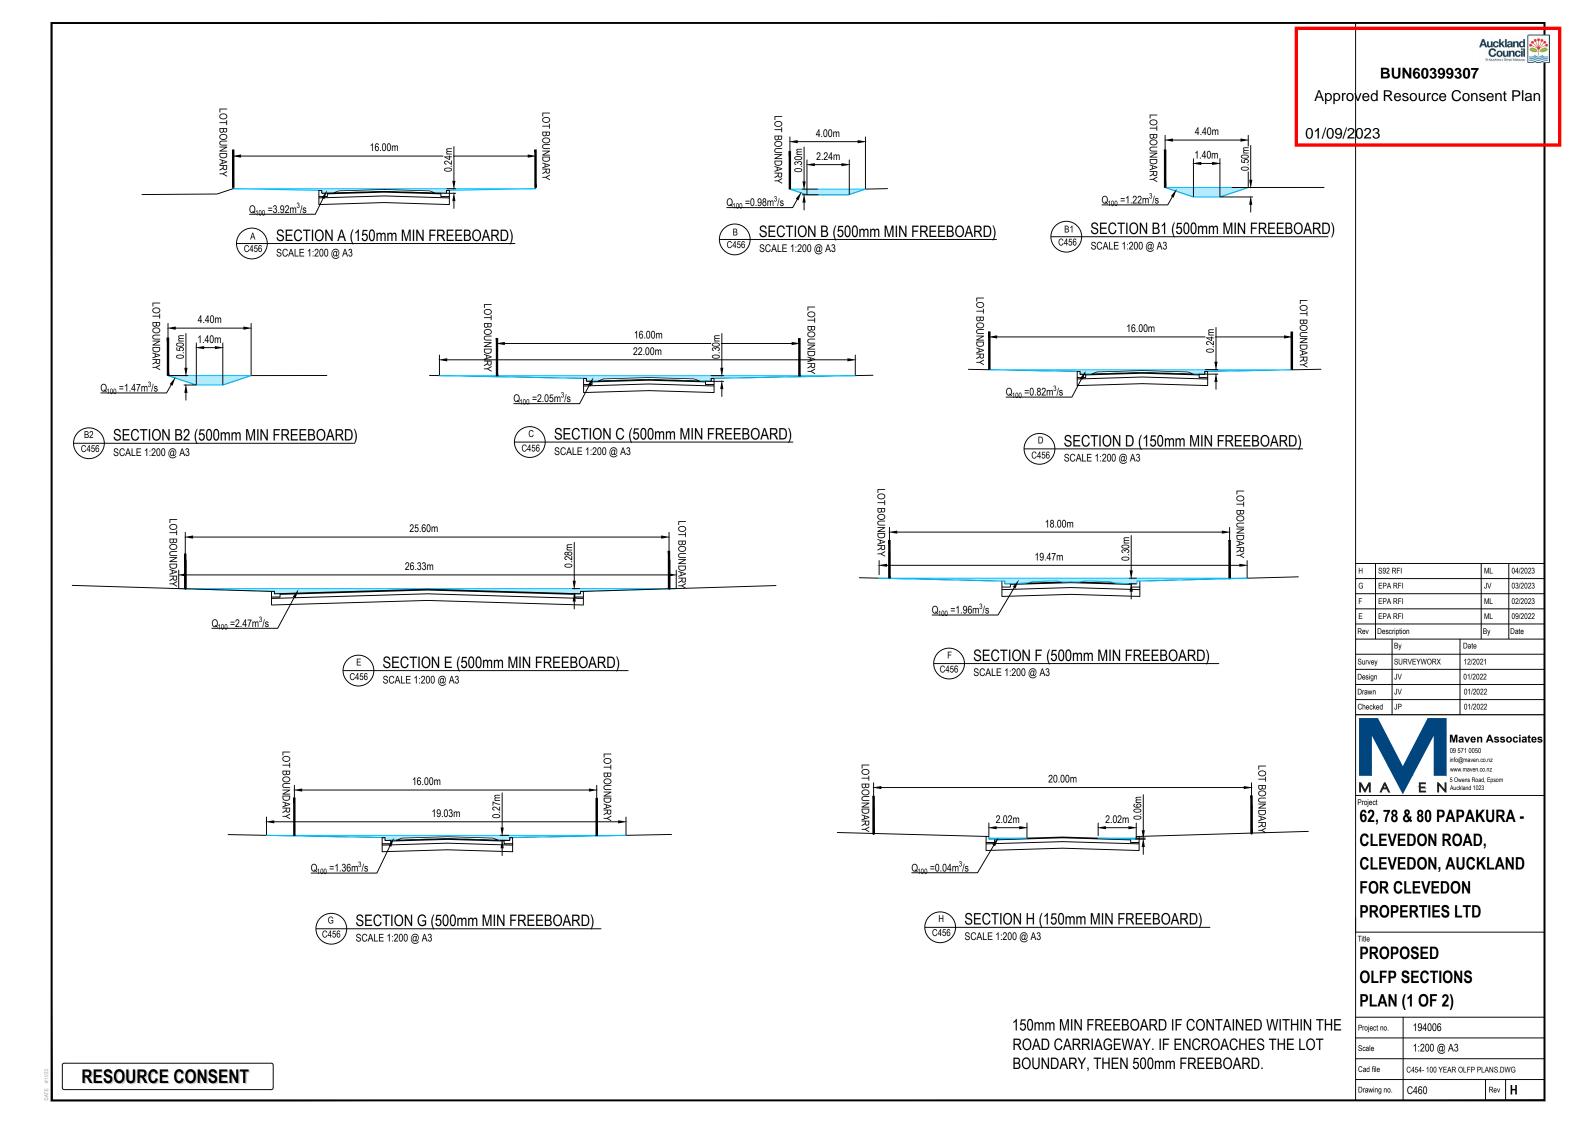


Auckland Council To Kasafee o Tanal Massas

BUN60399307


Approved Resource Consent Plan

01/09/2023

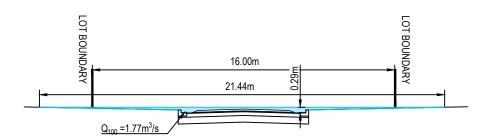


SECTION I (500mm MIN FREEBOARD)

C457 SCALE 1:200 @ A3

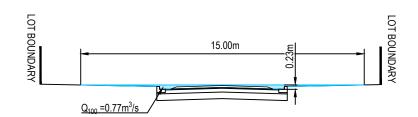

SECTION K (150mm MIN FREEBOARD)
SCALE 1:200 @ A3

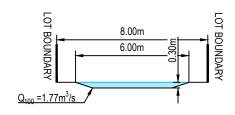

J SECTION J (150mm MIN FREEBOARD)

C457 SCALE 1:200 @ A3

Н	S92	S92 RFI		ML	04/2023
G	EPA	EPA RFI		JV	03/2023
F	EPA	EPA RFI		ML	02/2023
Е	EPA	A RFI		ML	09/2022
Rev	Desc	ription		Ву	Date
Ву		Date			
Survey		SURVEYWORX	12/2021		
Design		JV	01/2022		
Drawn		JV	01/20	01/2022	




62, 78 & 80 PAPAKURA CLEVEDON ROAD,
CLEVEDON, AUCKLAND
FOR CLEVEDON
PROPERTIES LTD


PROPOSED
OLFP SECTIONS
PLAN (2 OF 2)


Project no.	194006				
Scale	1:200 @ A3				
Cad file	C454- 100 YEAR OLFP PLANS.DWG				
Drawing no.	C461	Rev	Н		


150mm MIN FREEBOARD IF CONTAINED WITHIN THE ROAD CARRIAGEWAY. IF ENCROACHES THE LOT BOUNDARY, THEN 500mm FREEBOARD.

DECO	URCE	CONIC	CENT
KESU	UKCE	COIN	oen i

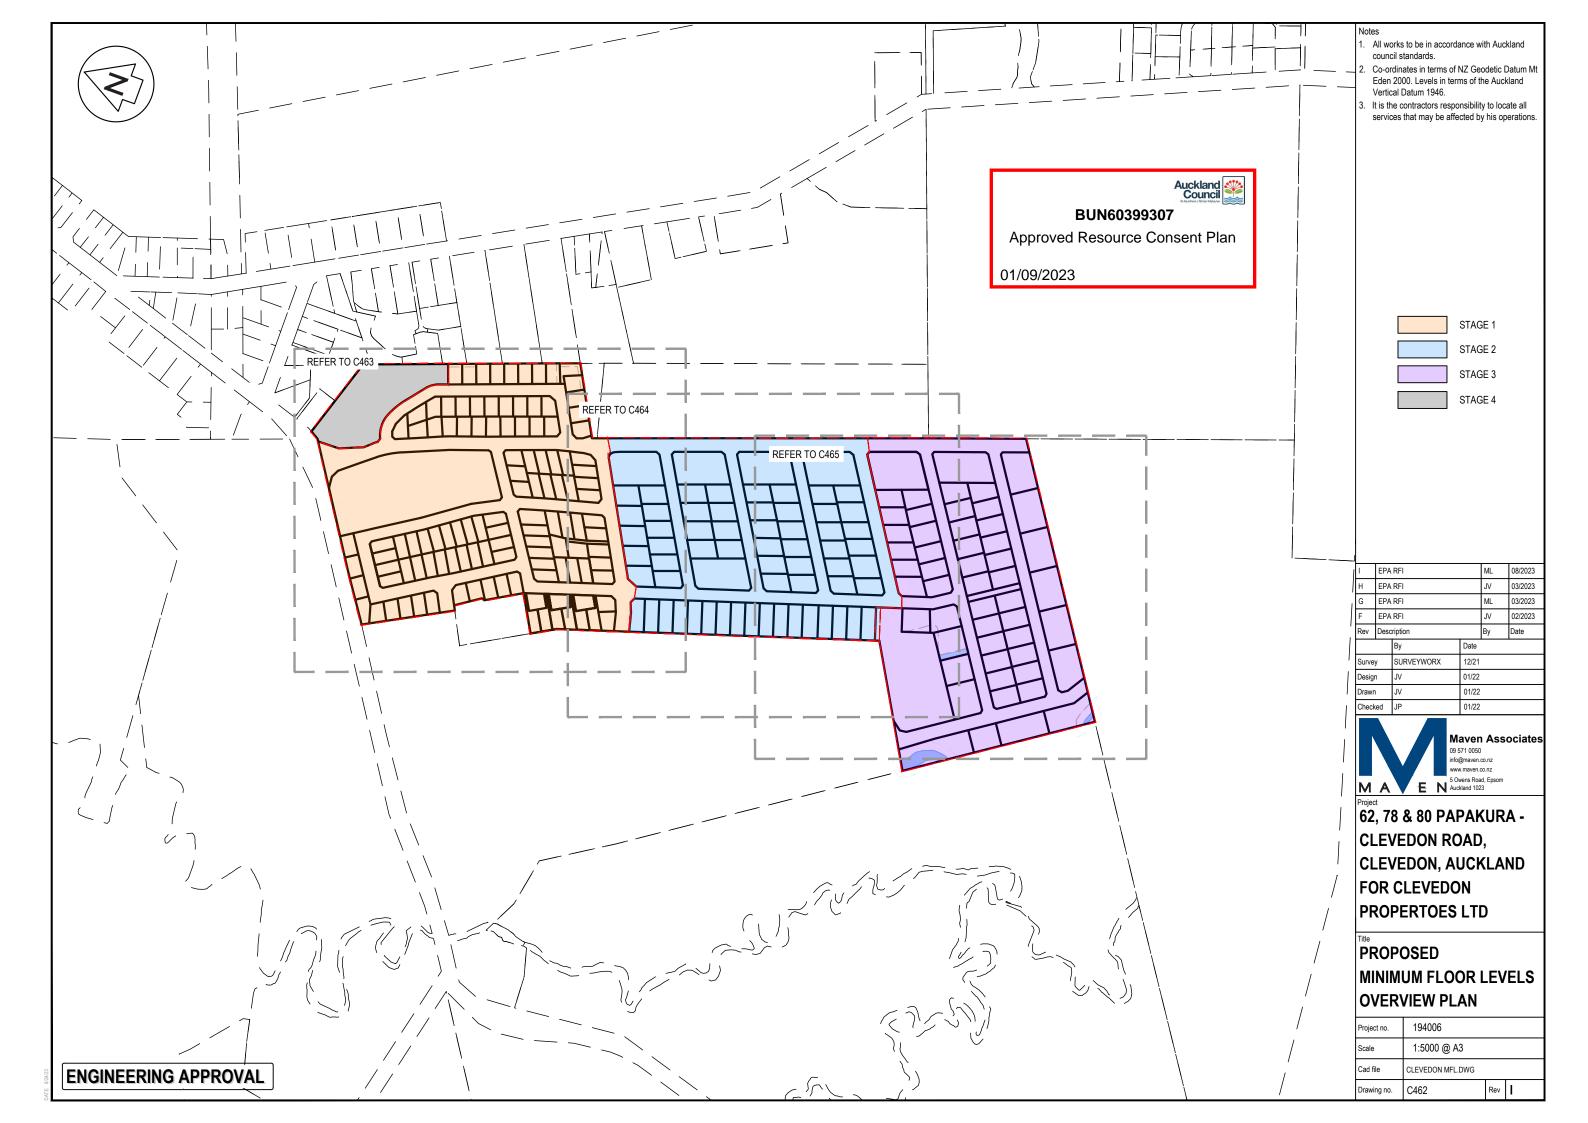

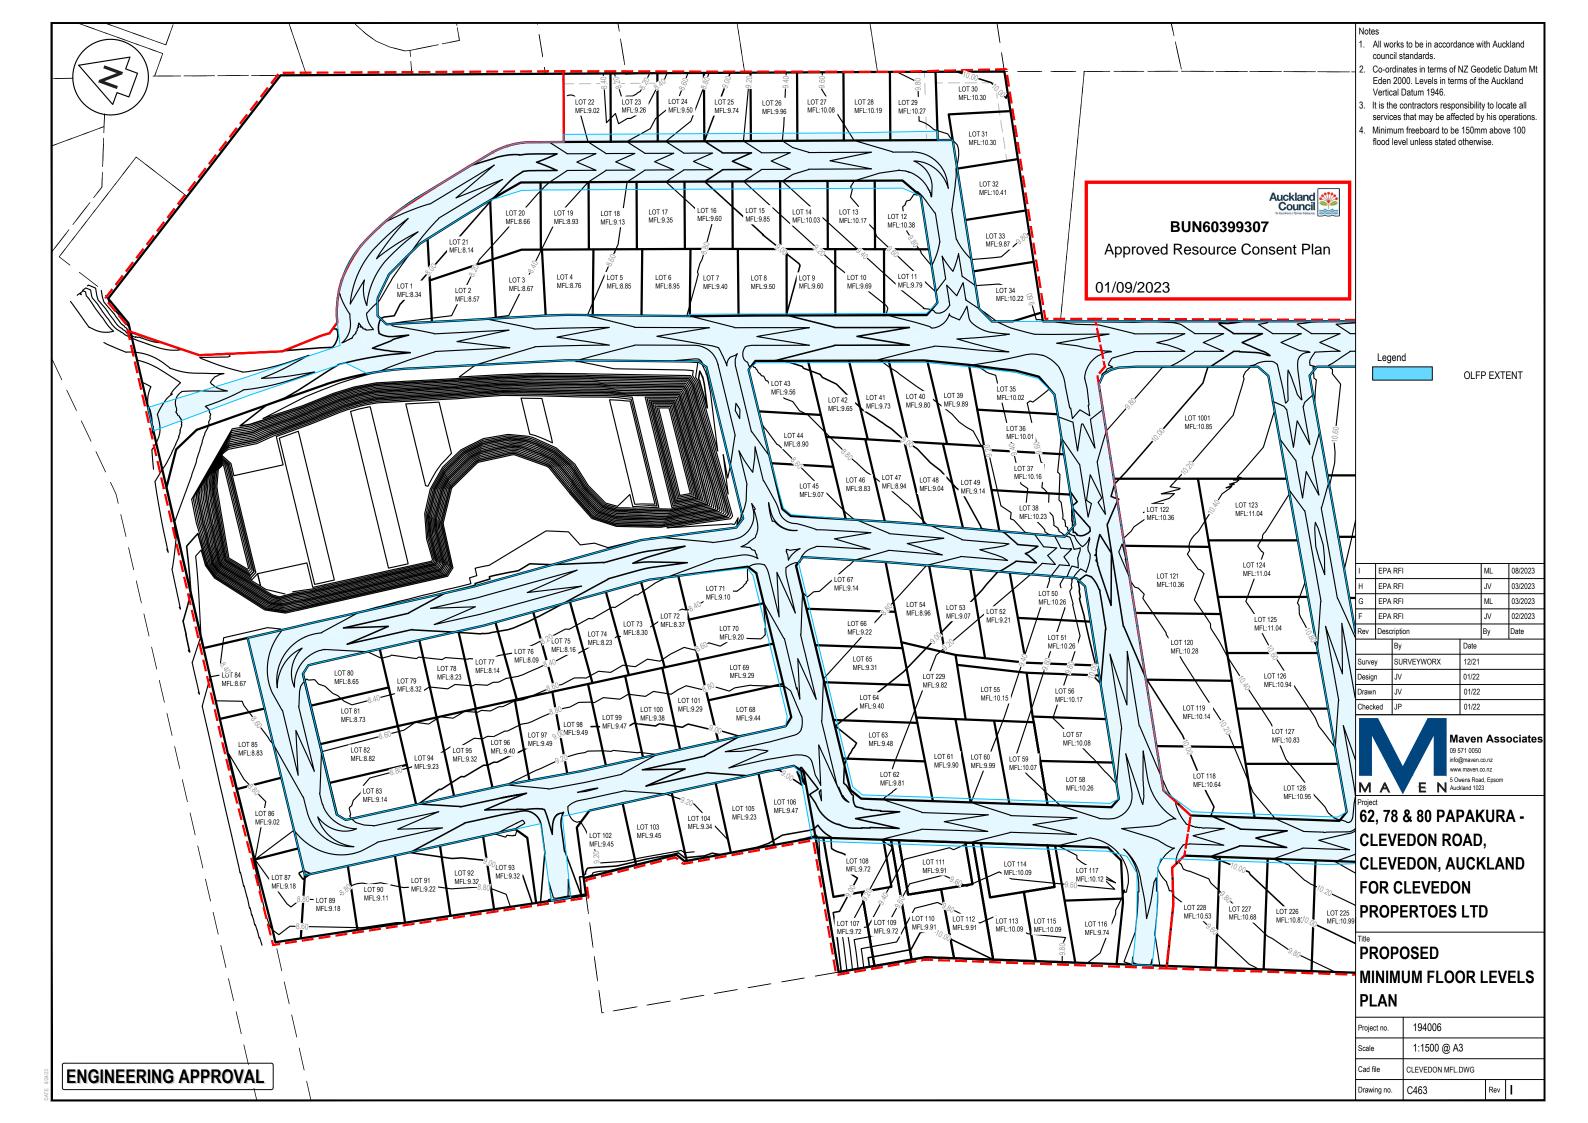

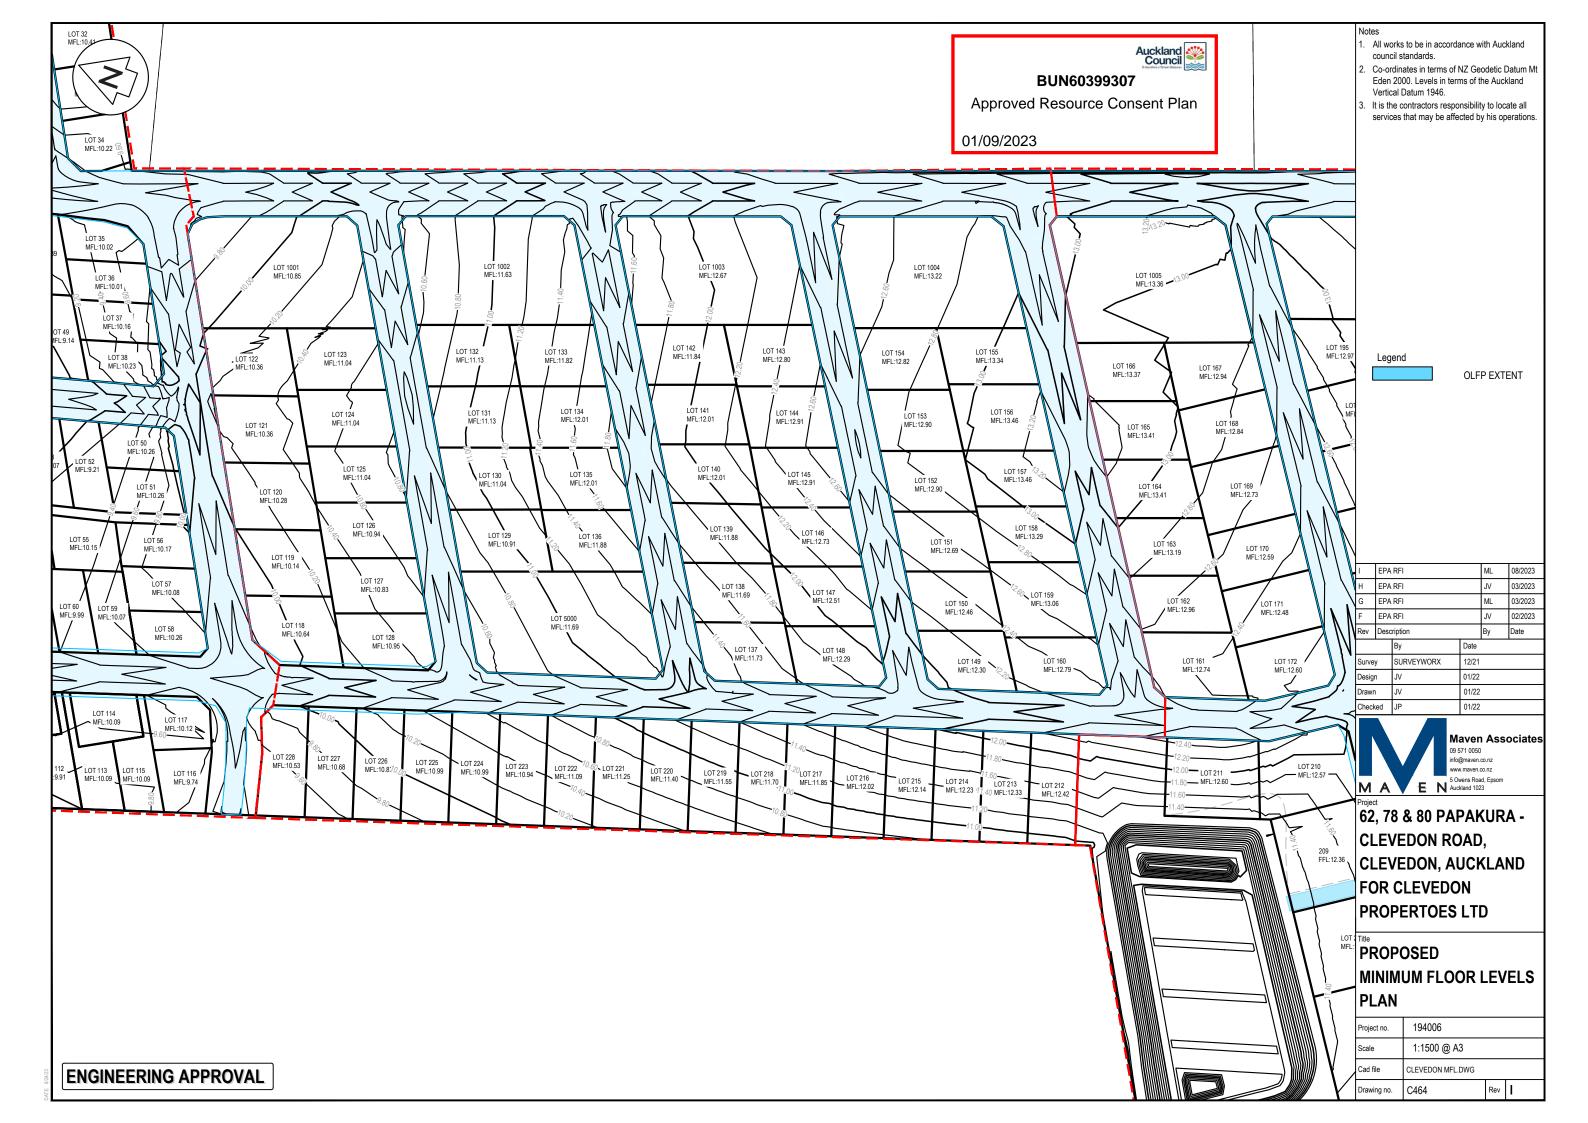

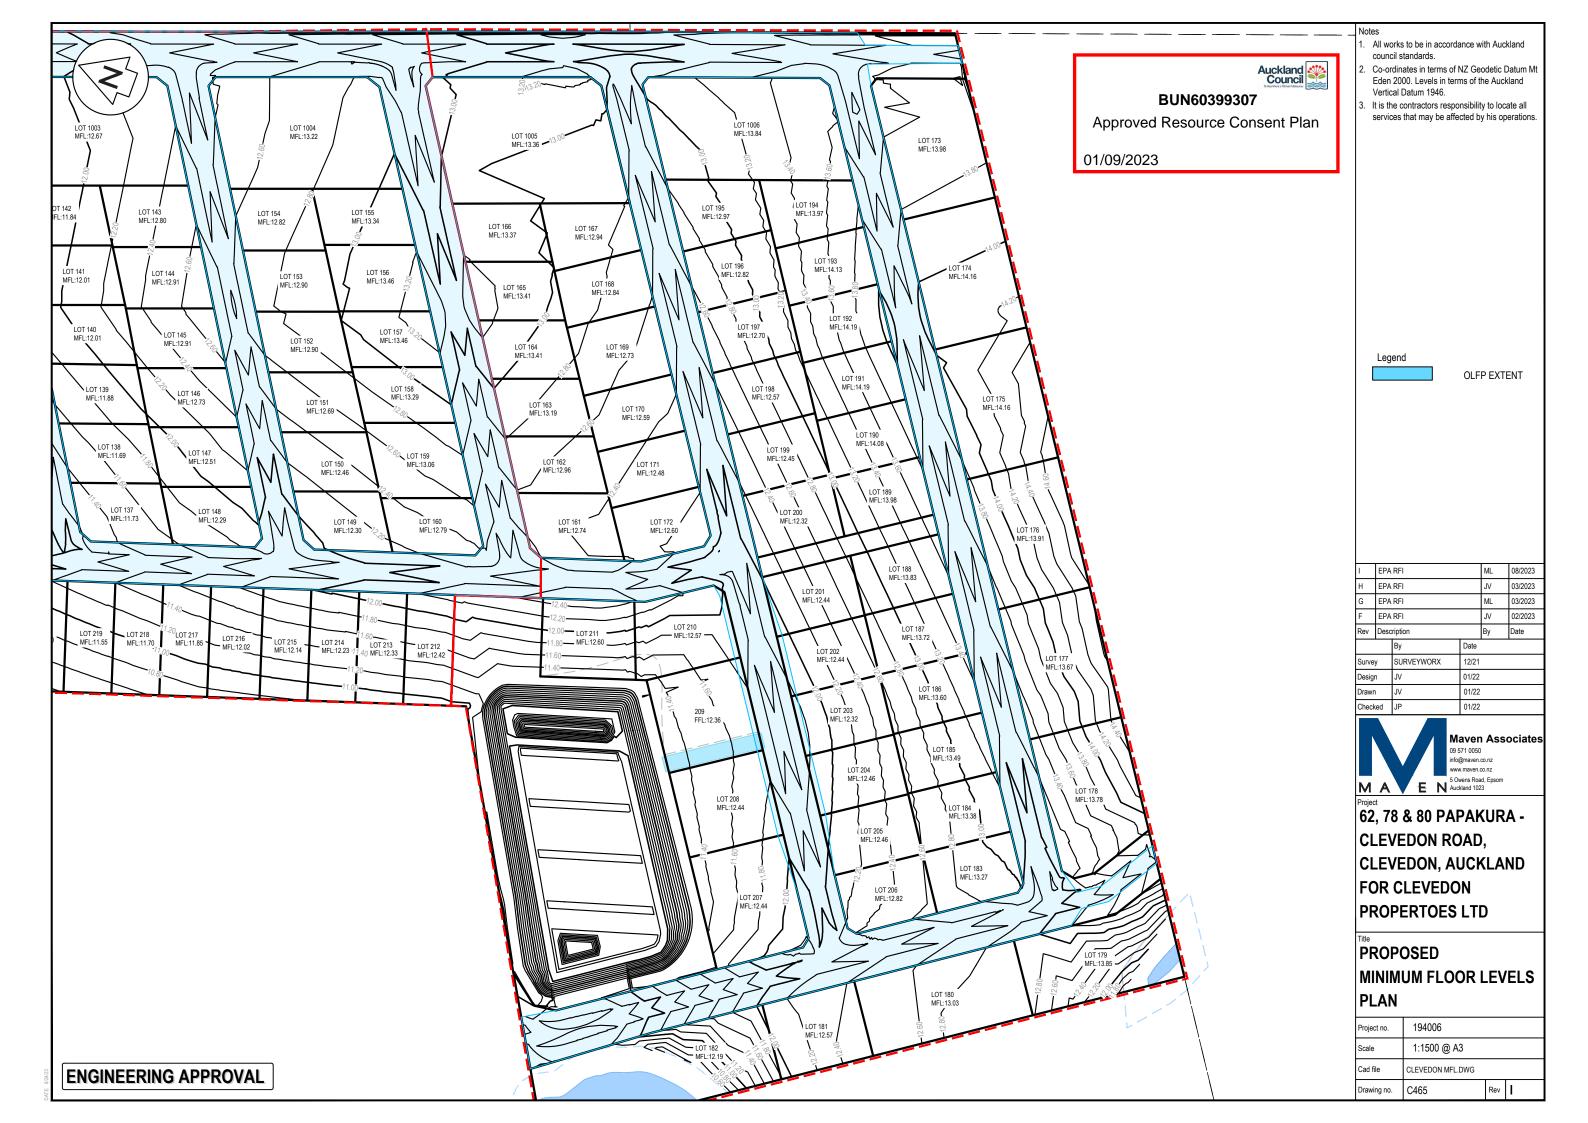

Point Table				
LOT NUMBER	MINIMUM FFL			
1	8.44m			
2	8.57m			
3	8.67m			
4	8.76m			
5	8.85m			
6	8.95m			
7	9.40m			
8	9.50m			
9	9.60m			
10	9.69m			
11	9.79m			
12	10.38m			
13	10.17m			
14	10.03m			
15	9.85m			
16	9.60m			
17	9.35m			
18	9.13m			
19	8.93m			
20	8.66m			
21	8.14m			
22	9.02m			
23	9.26m			
24	9.50m			
25	9.74m			
26	9.96m			
27	10.08m			
28	10.19m			
29	10.27m			
30	10.30m			
31	10.30m			
32	10.41m			
33	9.87m			
34	10.22m			
35	10.02m			
36	10.01m			
37	10.16m			
38	10.23m			
39	9.89m			
40	9.80m			

Point	Table
LOT NUMBER	MINIMUM FFL
41	9.73m
42	9.65m
43	9.56m
44	8.90m
45	9.07m
46	8.83m
47	8.94m
48	9.04m
49	9.14m
50 & 51	10.26m
52	9.21m
53	9.07m
54	8.96m
55	10.15m
56	10.17m
57	10.08m
58	10.26m
59	10.07m
60	9.99m
61	9.90m
62	9.81m
63	9.48m
64	9.40m
65	9.31m
66	9.22m
67	9.14m
68	9.44m
69	9.29m
70	9.20m
71	9.10m
72	8.37m
73	8.30m
74	8.23m
75	8.16m
76	8.09m
77	8.14m
78	8.23m
79	8.32m
80	8.65m
81	8.73m

Point	Table
LOT NUMBER	MINIMUM FFL
82	8.82m
83	9.14m
84	8.67m
85	8.83m
86	9.02m
87 & 89	9.18m
90	9.11m
91	9.22m
92 & 93	9.32m
94	9.23m
95	9.32m
96	9.40m
97 & 98	9.49m
99	9.47m
100	9.38m
101	9.29m
102 & 103	9.45m
104	9.34m
105	9.23m
106	9.47m
107, 108 & 109	9.72m
110, 111 & 112	9.91m
113, 114 & 115	10.09m
116	9.74m
117	10.12m
118	10.64m
119	10.14m
120	10.28m
121 & 122	10.36m
123 & 124	11.04m
125	11.04m
126	10.94m
127	10.83m
128	10.95m
129	10.91m
130	11.04m
131 & 132	11.13m
133	11.82m
134 & 135	12.01m
136	11.88m

Point Table		Poir
LOT NUMBER	MINIMUM FFL	LOT NUMBER
137	11.73m	183
138	11.69m	184
139	11.88m	185
140 & 141	12.01m	186
142	11.84m	187
143	12.80m	188
144 & 145	12.91m	189
146	12.73m	190
147	12.51m	191 & 192
148	12.29m	193
149	12.30m	194
150	12.46m	195
151	12.69m	196
152 & 153	12.90m	197
154	12.82m	198
155	13.34m	199
156 & 157	13.46m	200
158	13.29m	201 & 202
159	13.06m	203
160	12.79m	204 & 205
161	12.74m	206
162	12.96m	208 & 207
163	13.19m	209
164 & 165	13.41m	210
166	13.37m	211
167	12.94m	212
168	12.84m	213
169	12.73m	214
170	12.59m	215
171	12.48m	216
172	12.60m	217
173	13.98m	218
174 & 175	14.16m	219
176	13.91m	220
177	13.67m	221
178	13.78m	222
179	13.85m	223
180	13.03m	224 & 225
181	12.57m	226
182	12.19m	227
		-

12.70m

12.57m

12.45m

12.32m

12.44m

12.32m

12.46m

12.82m

12.44m

12.36m

12.57m

12.60m

12.42m

12.33m

12.23m

12.14m

12.02m

11.85m

11.70m

11.55m

11.40m

11.25m

11.09m

10.94m

10.99m

10.83m

10.68m

Point Table			Point Table		
OT NUMBER	MINIMUM FFL		LOT NUMBER MINIMU		
183	13.27m		228	10.53m	
184	13.38m		229	9.82m	
185	13.49m		1001	10.85m	
186	13.60m		1002	11.63m	
187	13.72m		1003	12.67m	
188	13.83m		1004	13.22m	
189	13.98m		1005	13.36m	
190	14.08m		1006	13.84m	
191 & 192	14.19m		5000	11.69m	
193	14.13m				
194	13.97m				
195	12.97m				
196	12.82m				

Auckland Council

BUN60399307

Approved Resource Consent Plan

01/09/2023

LOT NUMBER	MINIMUM FFL
228	10.53m
229	9.82m
1001	10.85m
1002	11.63m
1003	12.67m
1004	13.22m
1005	13.36m
1006	13.84m
5000	11.69m

ML 08/2023 EPA RFI JV 03/2023 EPA RFI 03/2023 EPA RFI ML EPA RFI 02/2023 JV Rev Description Date SURVEYWORX 12/21 01/22 01/22

All works to be in accordance with Auckland

Co-ordinates in terms of NZ Geodetic Datum Mi Eden 2000. Levels in terms of the Auckland

. It is the contractors responsibility to locate all services that may be affected by his operations.

council standards.

Vertical Datum 1946.

Maven Associates 09 571 0050 www.maven.co.nz M A E N Auckland 1023

01/22

62, 78 & 80 PAPAKURA -**CLEVEDON ROAD,**

CLEVEDON, AUCKLAND FOR CLEVEDON PROPERTOES LTD

PROPOSED MINIMUM FLOOR LEVELS **TABLE**

Project no.	194006		
Scale	-		
Cad file	CLEVEDON MFL.DWG		
Drawing no.	C466	Rev	I

ADDITIONAL NOTES:

IN ACCORDANCE WITH AUP:

1. WHERE OVERLAND FLOW PATH IS CONTAINED WITHIN THE ROAD CARRIAGEWAY AND FLOW IS LESS THAN 2m3/s, AS SIMPLIFIED METHOD (AND CONSERVATIVE), MINIMUM FINISHED FLOOR LEVELS HAVE BEEN ESTABLISHED BY ADDING 150MM FREEBOARD TO THE TOP OF KERB LEVEL.

2. WHERE OVERLAND FLOW PATH OVERTOPS THE KERB AND FLOW IS LESS THAN 2m3/sec, MINIMUM FINISHED FLOOR LEVELS HAVE BEEN ESTABLIHSED BY ADDING 150MM FREEBOARD TO THE TOP OF THE 100 YEAR FLOOD LEVEL.

3. MINIMUM 500MM FREEBOARD HAS BEEN PROVIDED WHERE FLOWS ARE MORE THAN 2m3/sec AND/OR ENCROACHES THE LOT BOUNDARIES.

ENGINEERING APPROVAL

